


BOSTON PUBLIC HEALTH COMMISSION

112 Southampton Street Entryway Interior Renovation

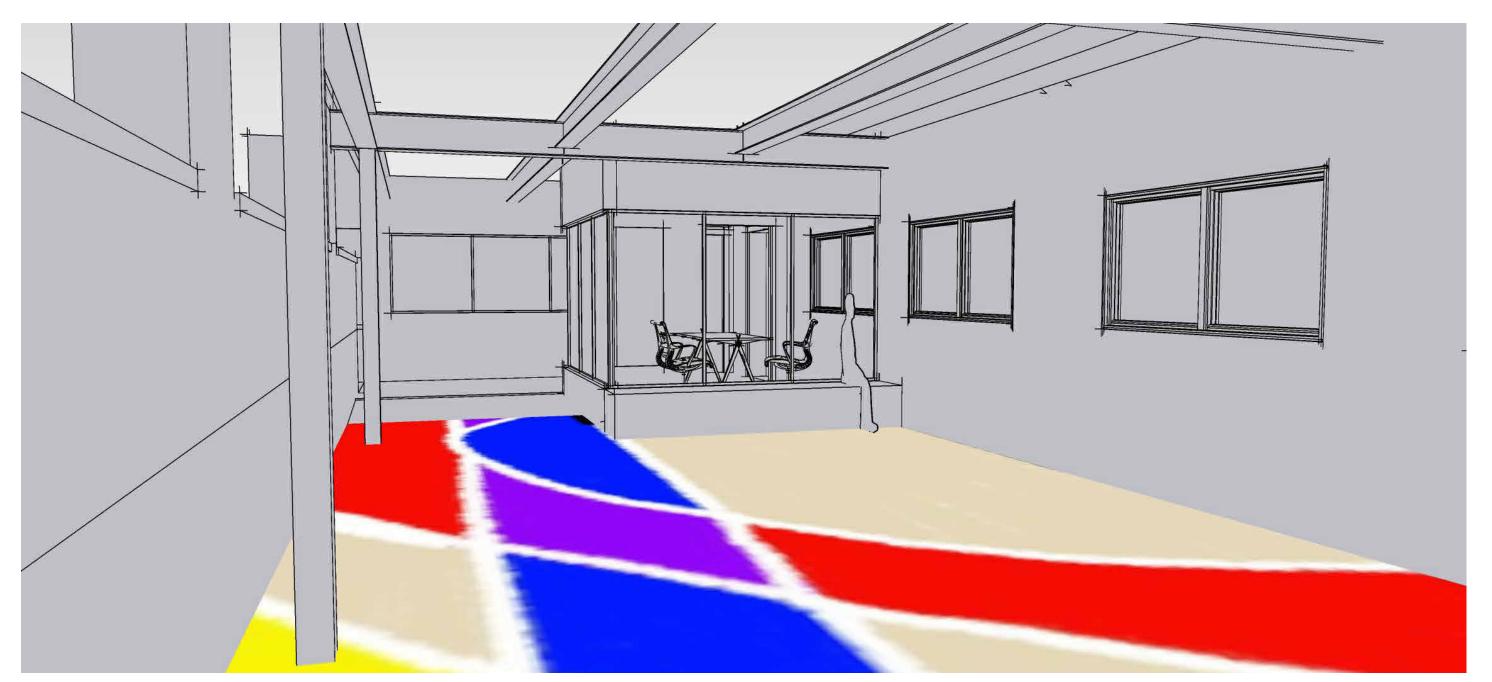



— PROJECT SITE

GENERAL NOTES:

- 1. THE GENERAL CONTRACTOR (GC OR CONTRACTOR) SHALL PERFORM ALL WORK IN ACCORDANCE WITH THE 9TH EDITION OF THE MA STATE BUILDING CODE (IBC 2015 WITH MA AMENDMENTS) AND ALL OTHER APPLICABLE CODES AND LOCAL ORDINANCES.
- 2. GC IS RESPONSIBLE FOR COORDINATING ALL WORK FOR ALL PROJECT REQUIREMENTS.
 IT IS THE RESPONSIBILITY OF THE GC TO COORDINATE THE SCOPE AND NATURE OF THE WORK
 REQUIRED FOR A COMPLETE INSTALLATION FROM THE INFORMATION PROVIDED IN THE DRAWINGS,
 NOTES AND PROJECT MANUAL.
- 3. CONTRACTOR SHALL FIELD VERIFY ALL DIMENSIONS & CONDITIONS PRIOR TO BEGINNING ANY WORK.
- 4. DO NOT SCALE DRAWINGS. ANY DEVIATIONS SHALL BE BROUGHT TO THE ATTENTION OF THE ARCHITECT. ALL DEVIATIONS AND DISCREPANCIES SHALL BE CORRECTED BY THE CONTRACTOR PRIOR TO COMMENCEMENT OF A PORTION OF THE WORK.
- SELECTIVE DEMOLITION: IT IS THE RESPONSIBILITY OF THE GC TO DETERMINE THE SCOPE AND NATURE OF EXISTING MATERIALS, EQUIPMENT AND FINISHED REQUIRED FOR REMOVAL, REPLACEMENT OR SALVAGE.
 CUTTING AND PATCHING COORDINATION: THE GC IS RESPONSIBLE FOR COORDINATION OF ALL
- CUTTING AND PATCHING NECESSARY FOR THE COMPLETION OF THE WORK AND FOR THE QUALITY AND APPEARANCE OF ALL PATCH WORK IN EXPOSED-TO-VIEW FINISHED MATERIALS. FULLY INTEGRATE WITH EXISTING AND NEW CONSTRUCTION. ALL CUTTING, ALTERATIONS AND PATCHING, TO PRESENT THE VISUAL APPEARANCE OF AN ENTIRE, COMPLETED, AND UNIFIED PROJECT.

 ALL WALLS, PARTITION AND CEILING AREAS NOT COVERED BY OTHER FINISHES SHALL BE PAINTED.
- PAINT TRIMS, BASEBOARDS, AND DOORS PER SCHEDULE. REFINISH SURFACES TO MATCH ADJECENT FINISHES UNLESS OTHERWISE NOTED. CONDITIONS NOT SPECIFICALLY SHOWN SHOULD MATCH EXISTING CONDITIONS.

DRAWING INDEX

ARCHITECTURAL SHEET # SHEET TITLE

A000 COVER SHEET

A100 DEMO PLAN, FLOOR PLAN A101 ENLARGED PLAN & FURNITURE, RCP


A200 INTERIOR ELEVATIONS
A201 INTERIOR ELEVATIONS
A300 PARTITIONS, FINISH SCHEDULE


A400 EXTERIOR DETAILS A500 IMAGERY

ELECTRICAL

E001 GENERAL SHEET
E100 FIRST FLOOR - DEMOLITION PLAN
E101 FIRST FLOOR - POWER AND LIGHTING PLAN
E600 SPECIFICATIONS



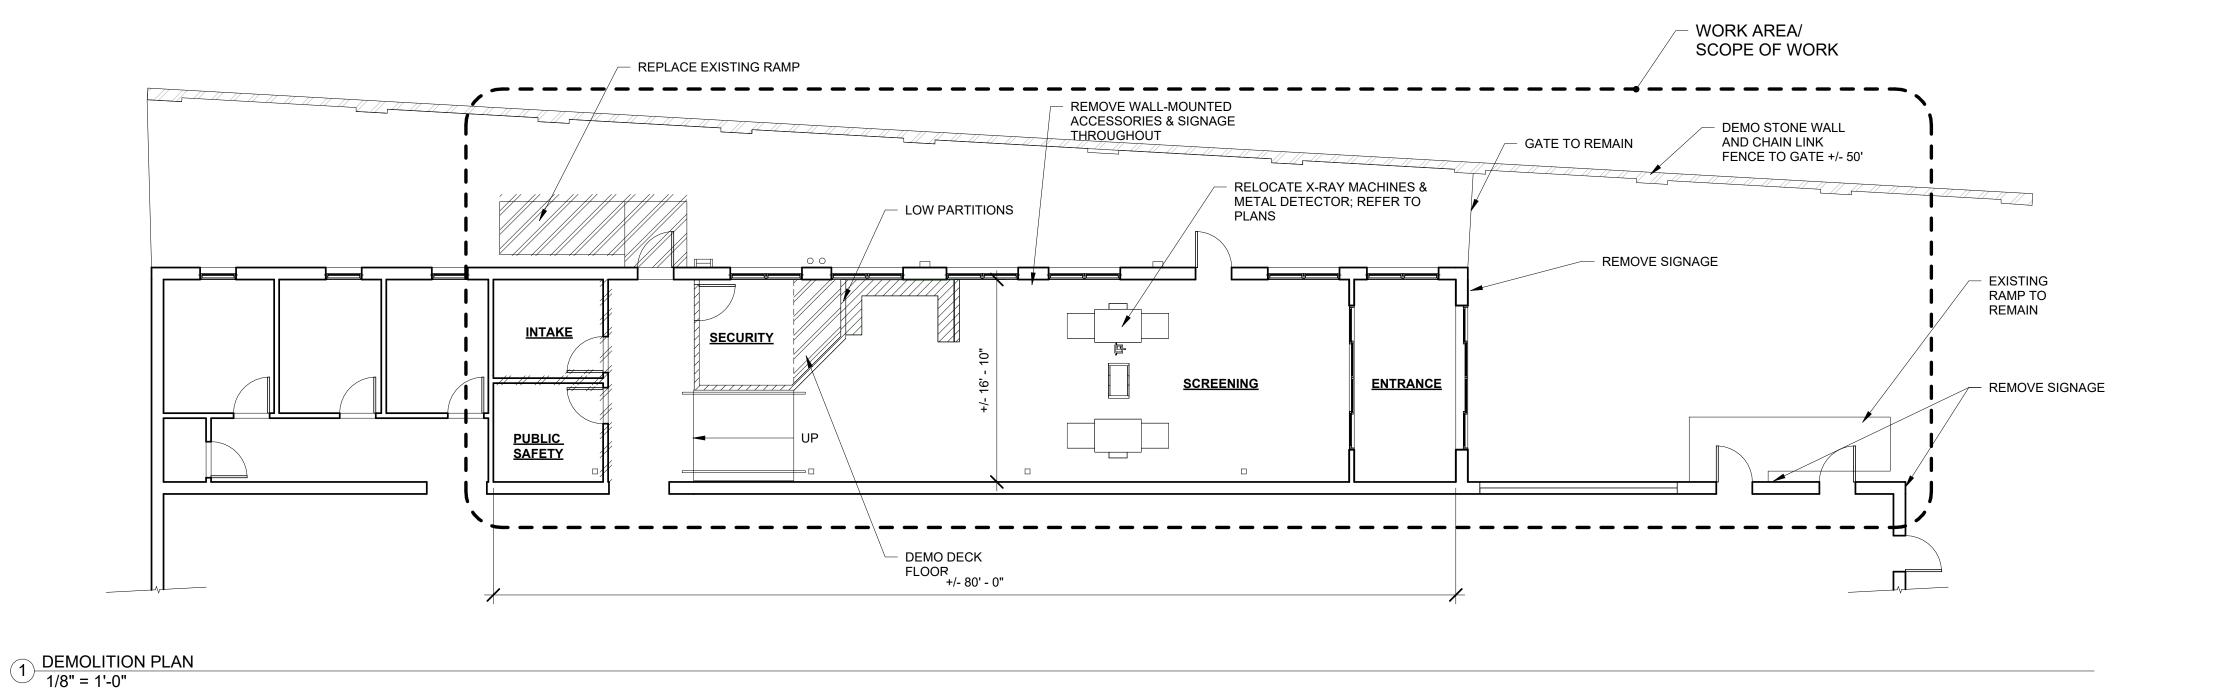

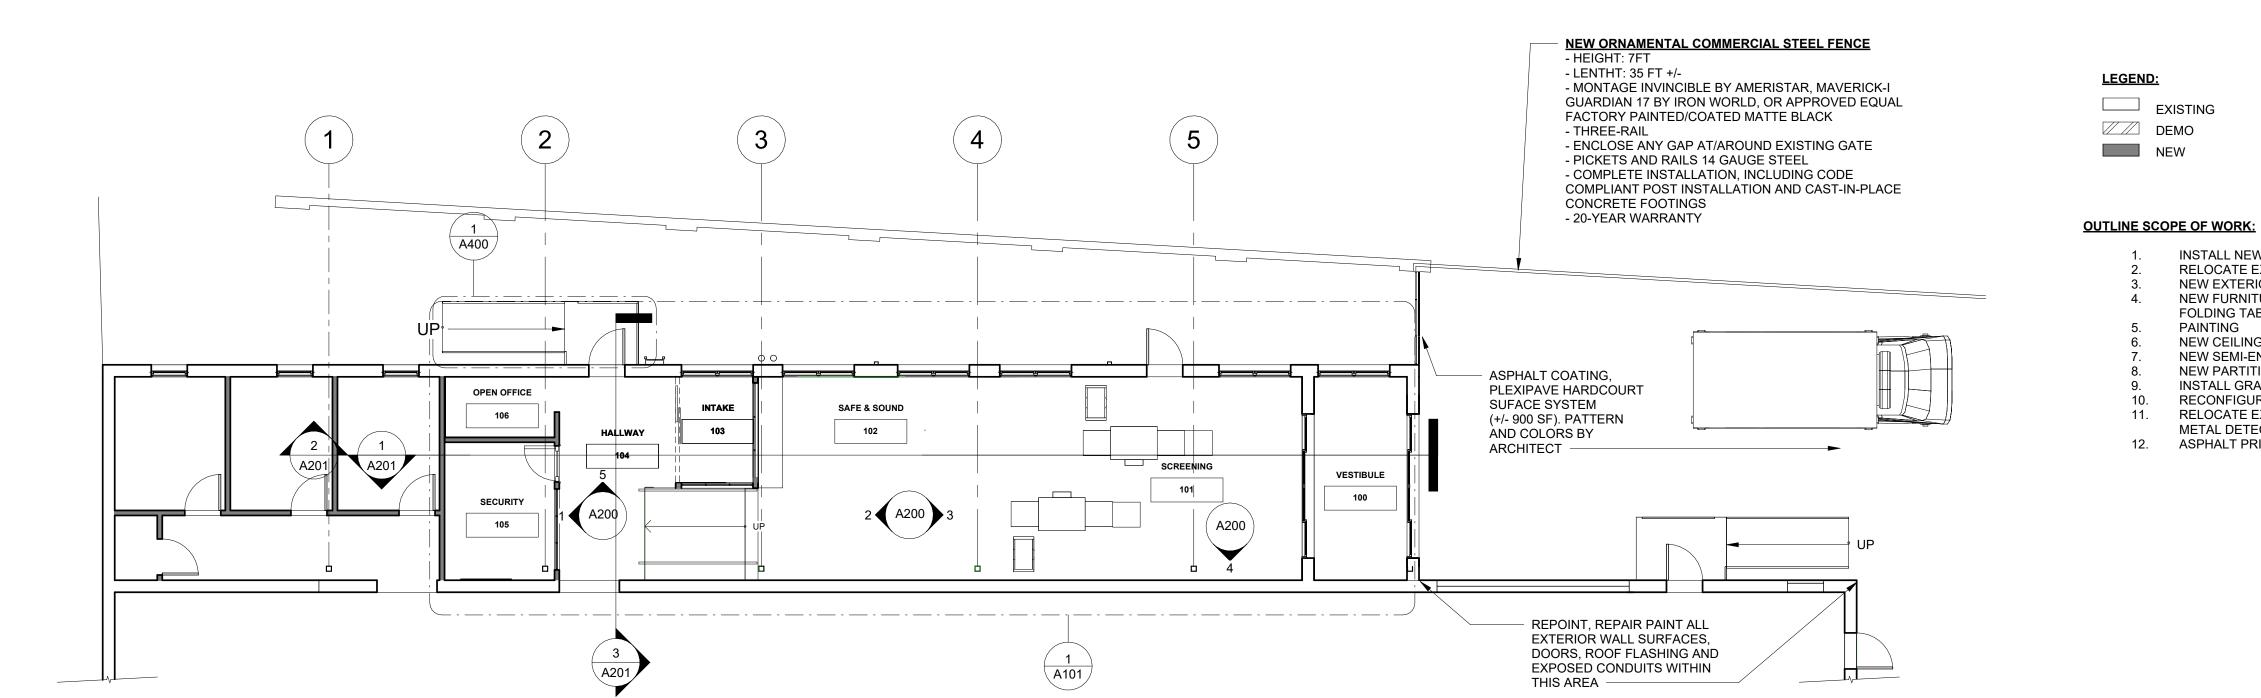

2 FIRST FLOOR PLAN 1/8" = 1'-0"



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PROJECT

112 Southampton Entryway Interior Renovation

Project Status: BID DOCUMENTS Issue Date: 06/23/2023 File: LAA/Projects/2113 Drawn by: LAA Checked by: LA

CLIENT

Boston Public Health Commission

STAMP

INSTALL NEW FLOORING THROUGHOUT WORK AREA RELOCATE EXISTING X-RAY MACHINES

NEW EXTERIOR REAR RAMP & FENCE NEW FURNITURE, INCLUDING GERI CHAIRS AND

RELOCATE EXISTING X-RAYS MACHINE AND NEW

METAL DETECTOR (PMD2 Plus purchaed by owner)

FOLDING TABLES

NEW CEILING CLOUDS
NEW SEMI-ENCLOSED INTAKE
NEW PARTITIONS AND GLAZING
INSTALL GRAPHICS & SIGNAGE

RECONFIGURE SECURITY ROOM

ASPHALT PRINTING AT ENTRANCE

PAINTING




REVISIONS

NO. Date Description

SHEET TITLE

DEMO PLAN, FLOOR PLAN

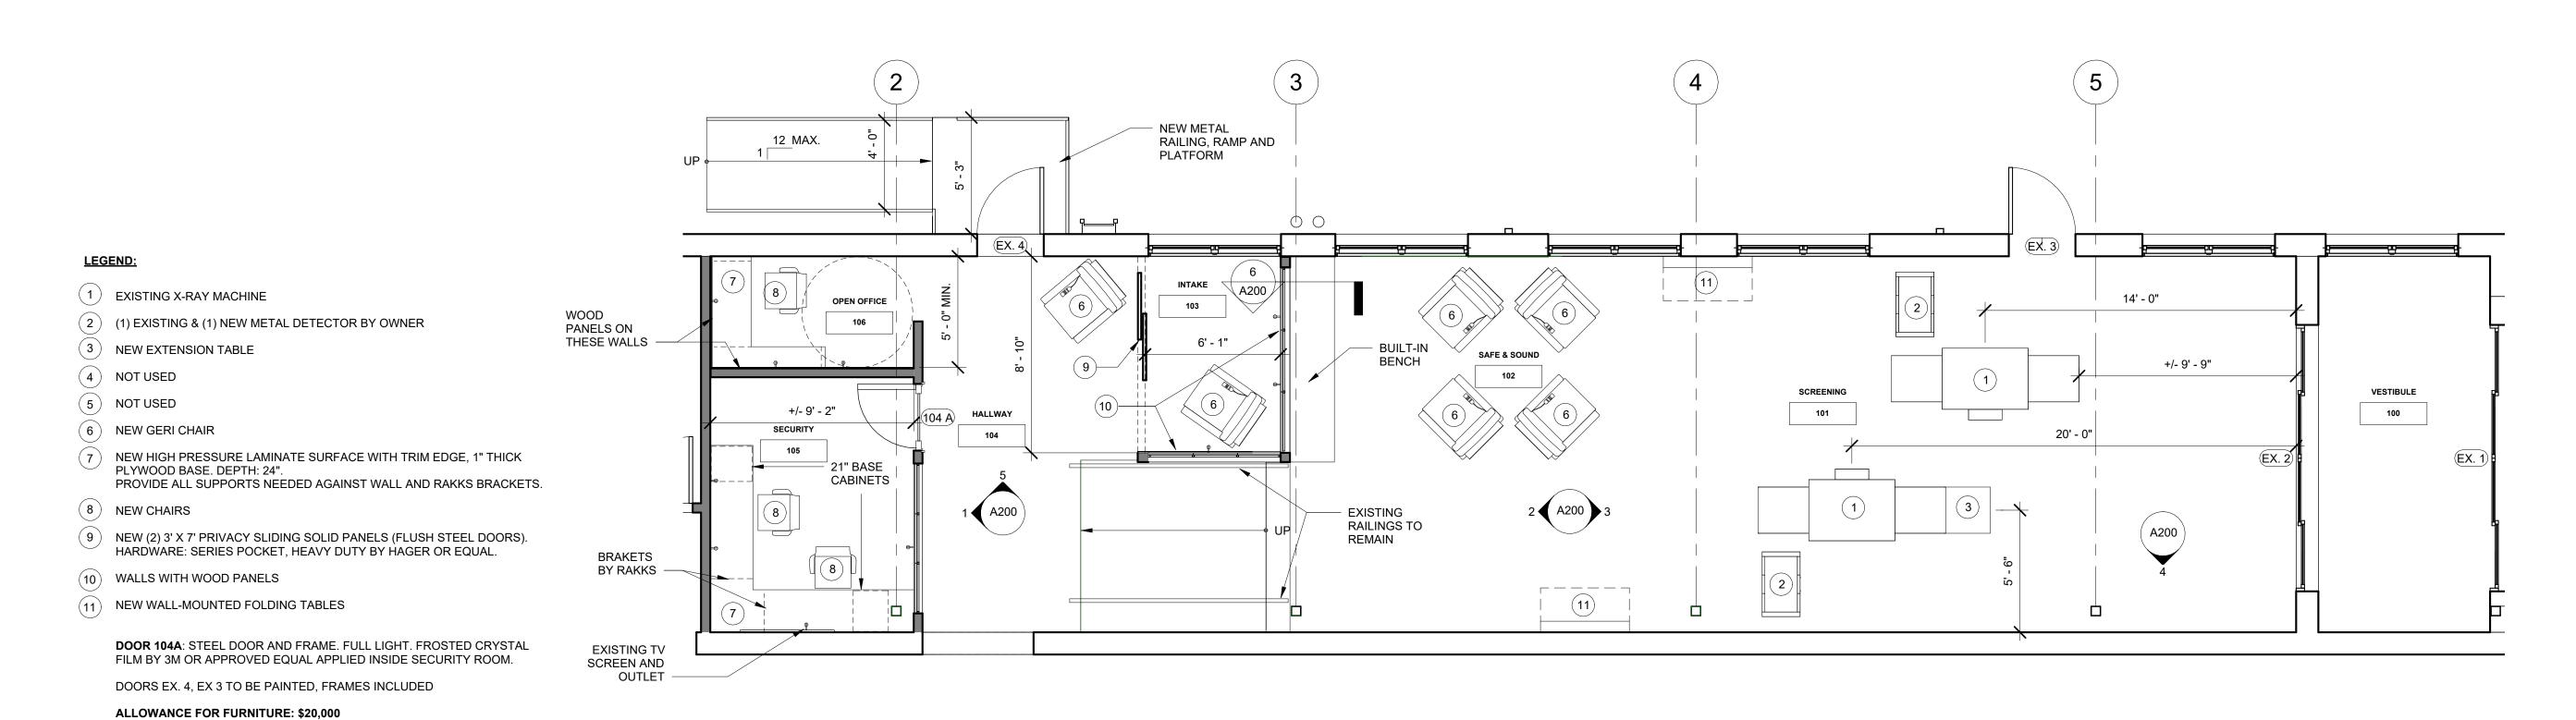


1 FLOOR PLAN 1/4" = 1'-0"

B: NEW FIXTURE

SPRINKLER HEAD (EXISTING)

CLOUD CEILING INTEGRATED LIGHTING

LEGEND:

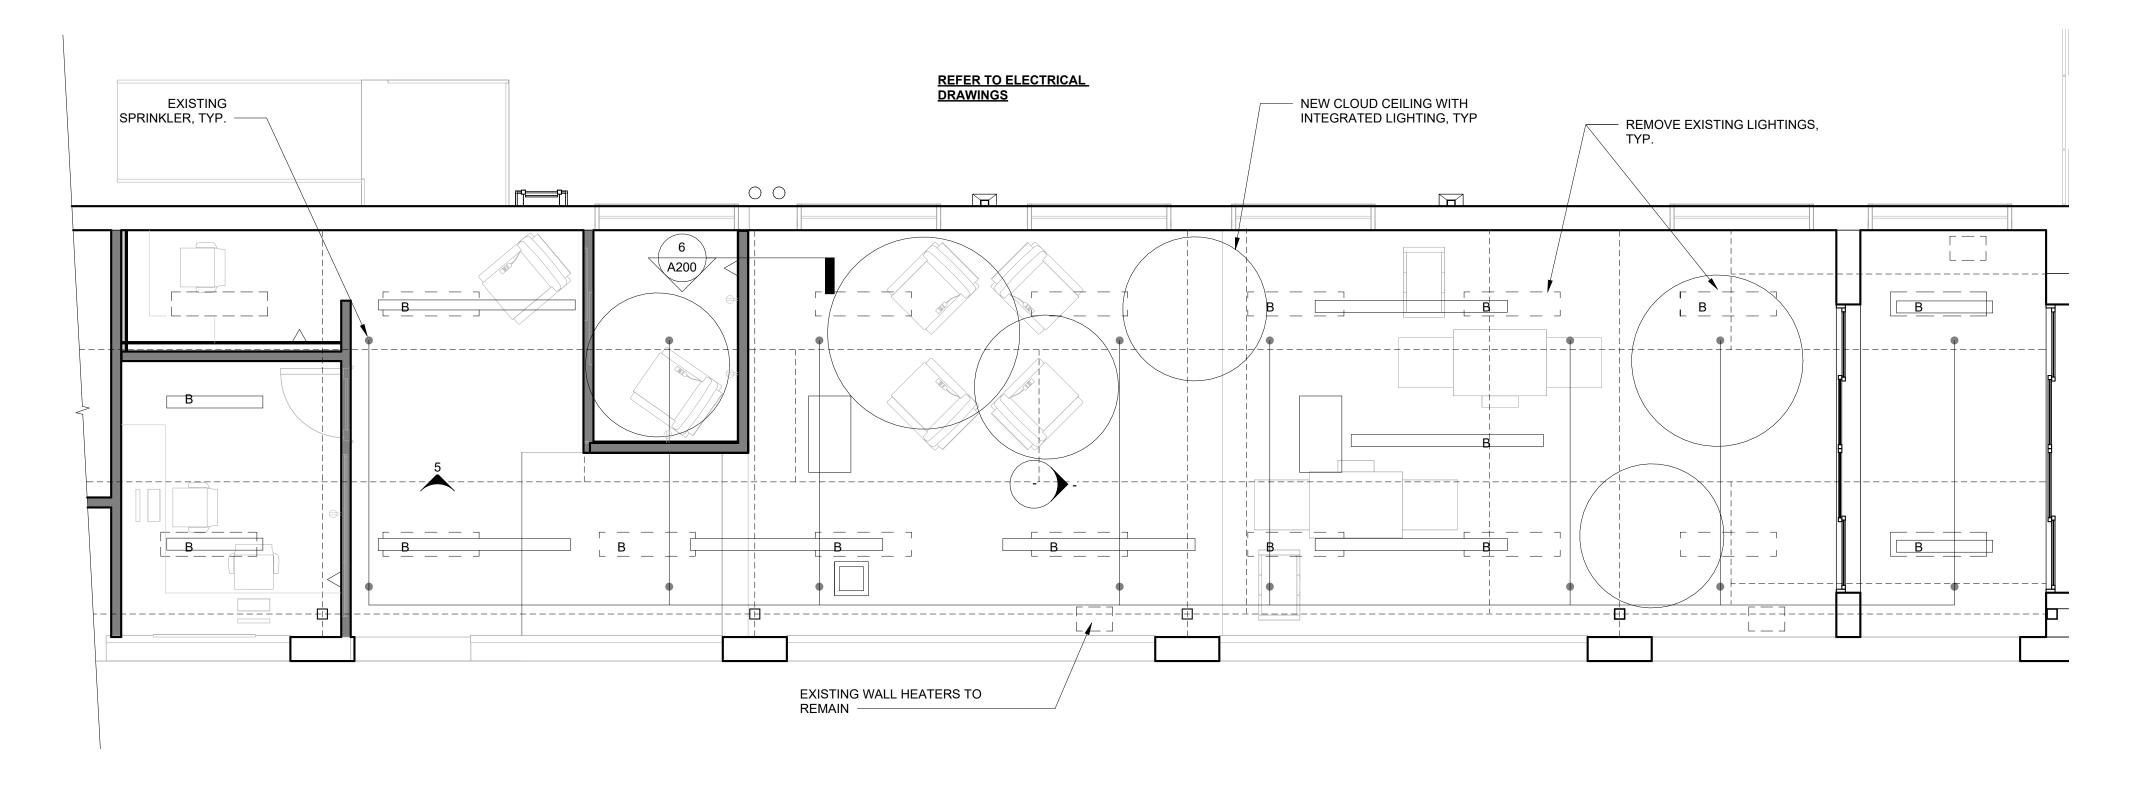

2 REFLECTED CEILING PLAN 1/4" = 1'-0"



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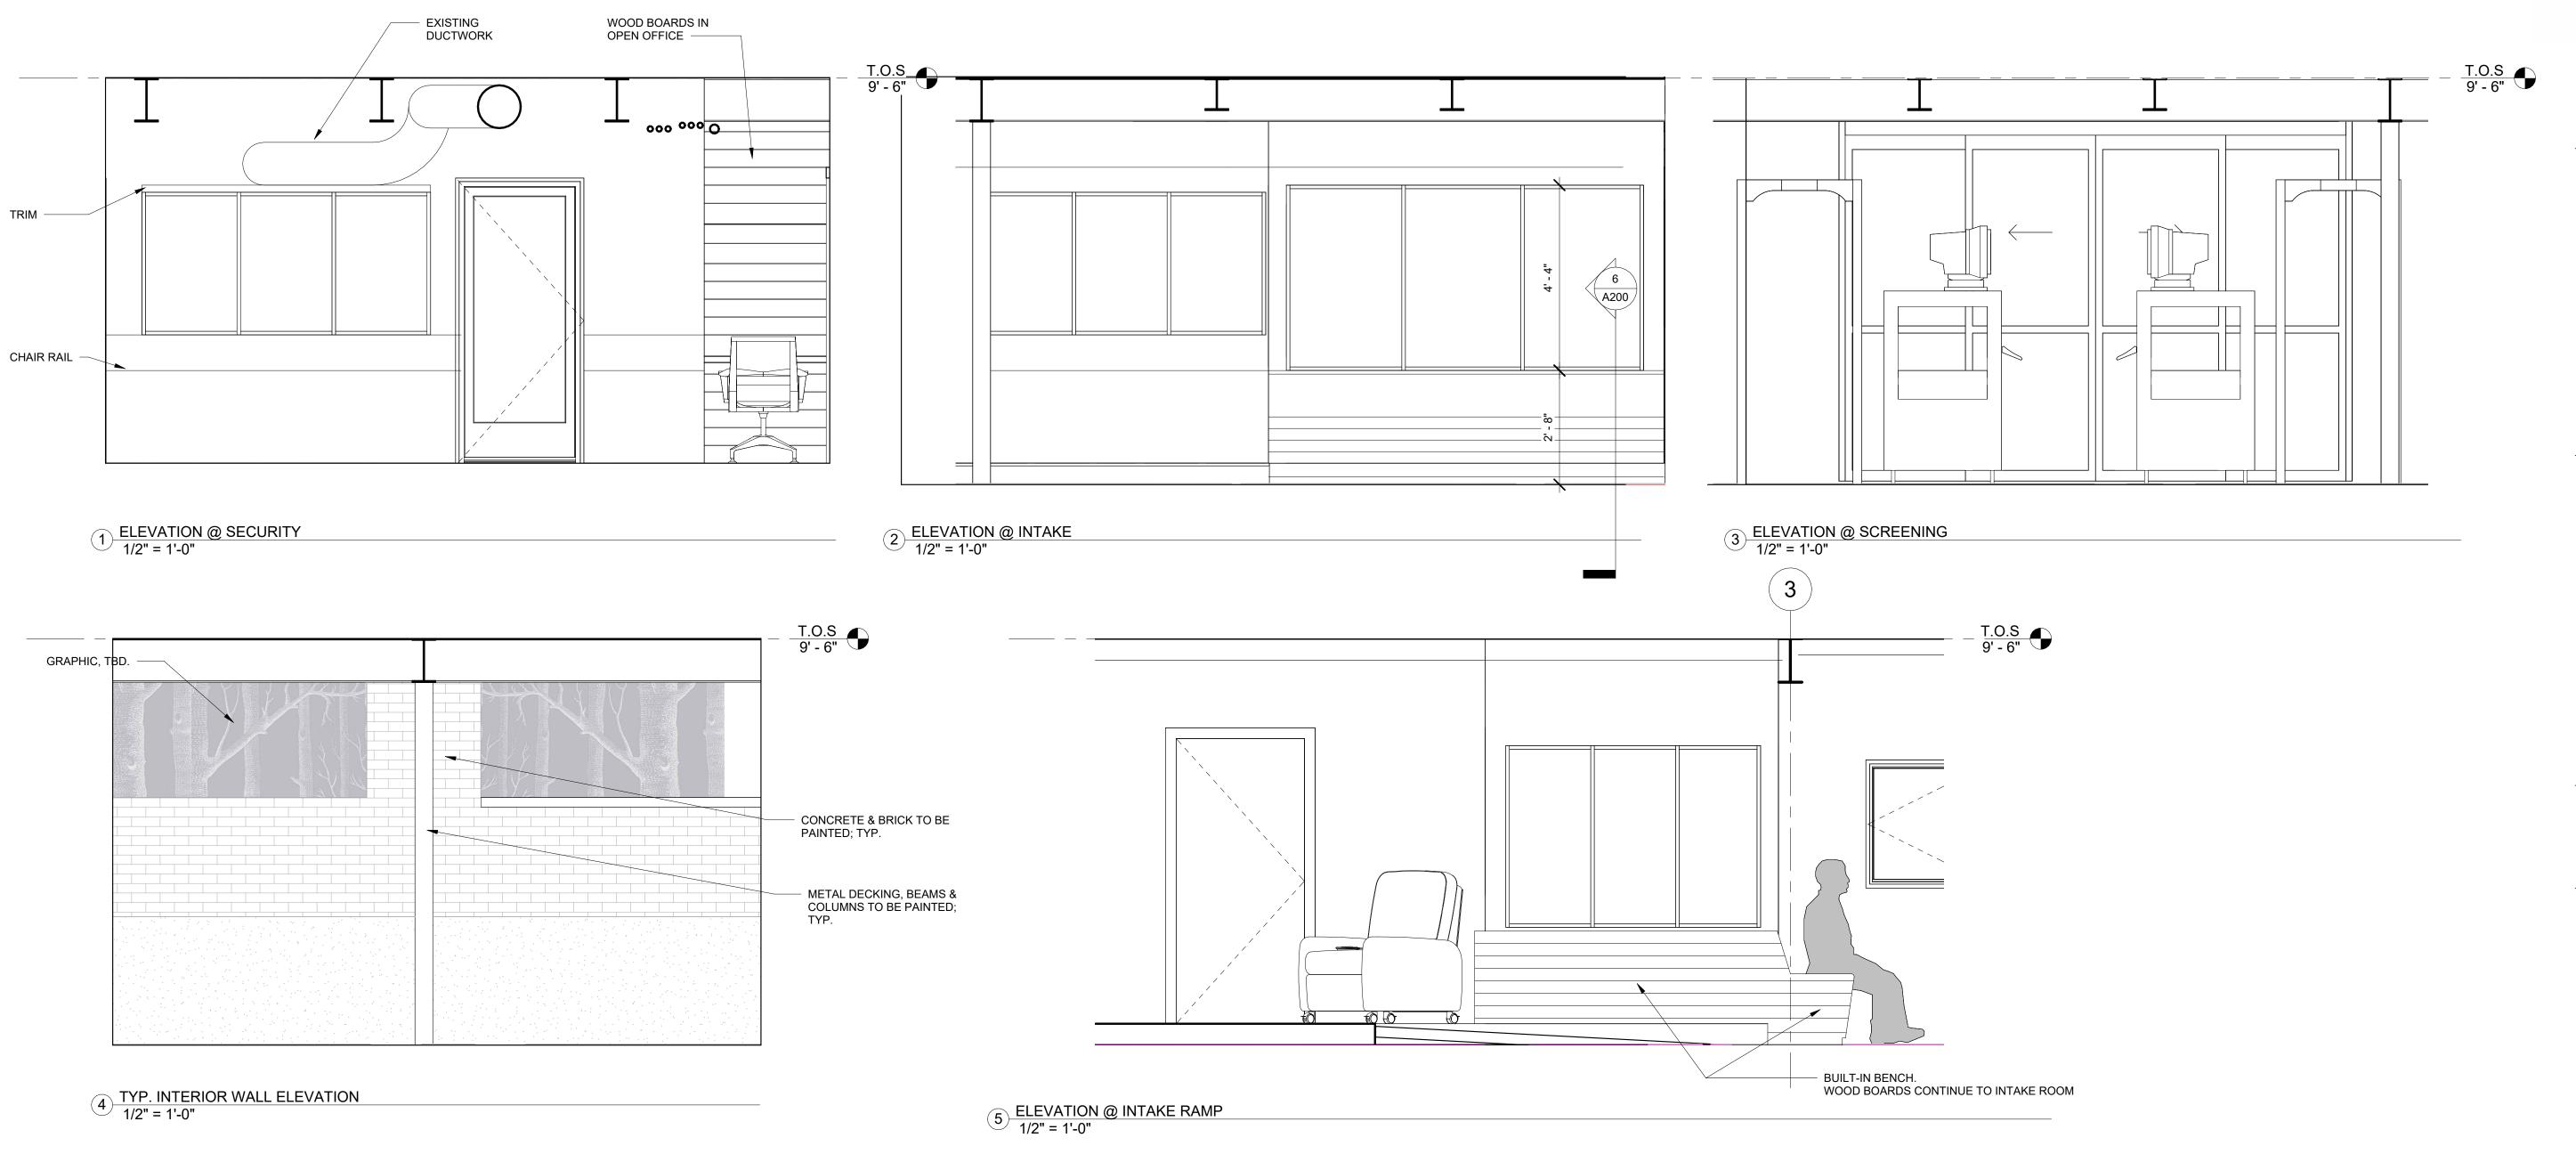
REVISIONS

NO. Date Description

SHEET TITLE

ENLARGED PLAN FURNITURE, RCP

A101





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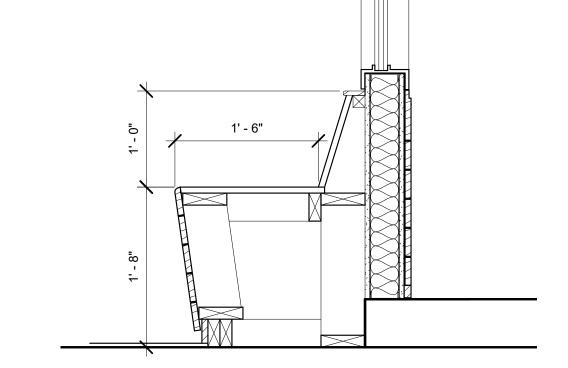
REVISIONS

NO. Date Description


SHEET TITLE


INTERIOR ELEVATIONS

A200





6 SECTION @ BUILT-IN BENCH 1" = 1'-0"

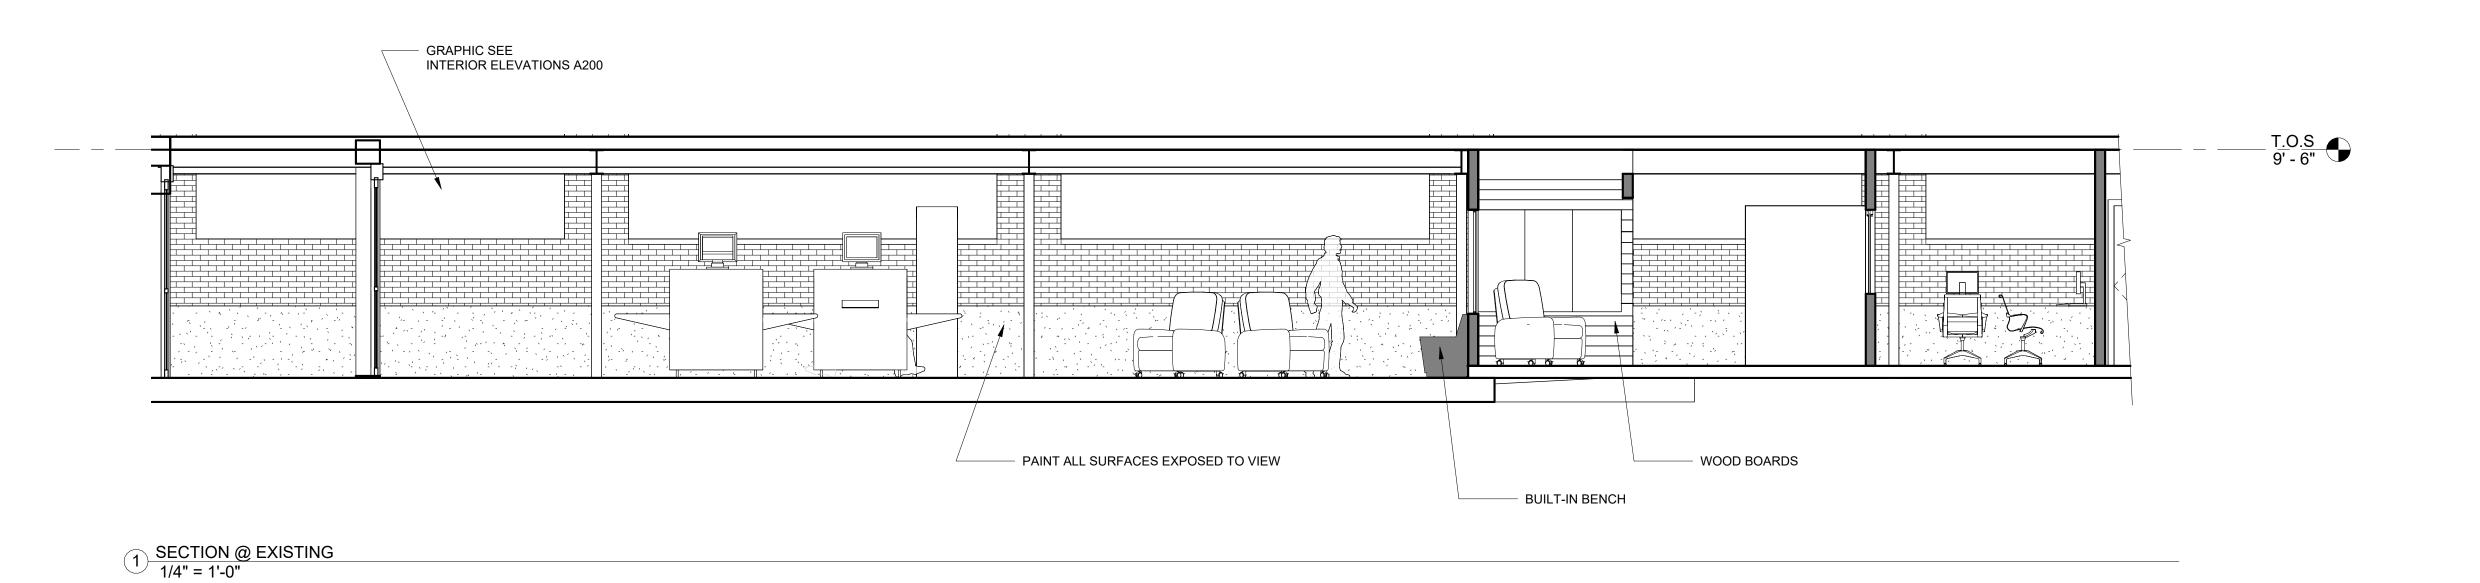

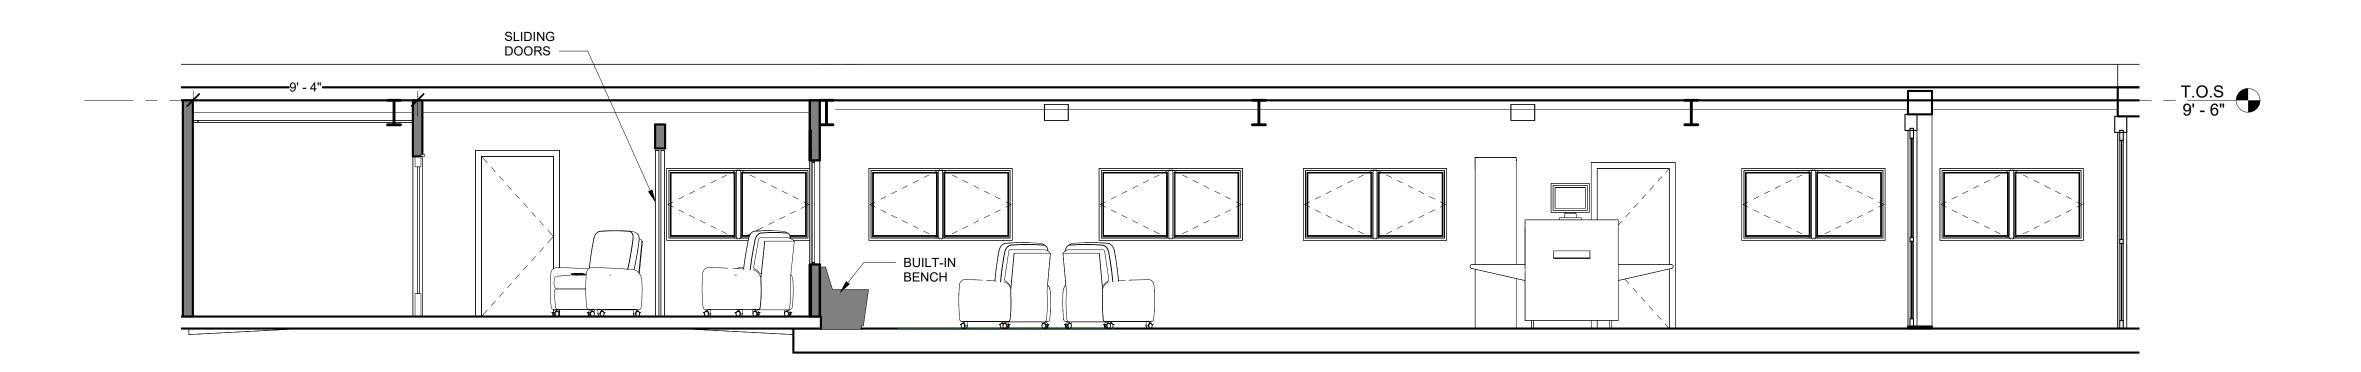

2 SECTION SOUTH 1/4" = 1'-0"

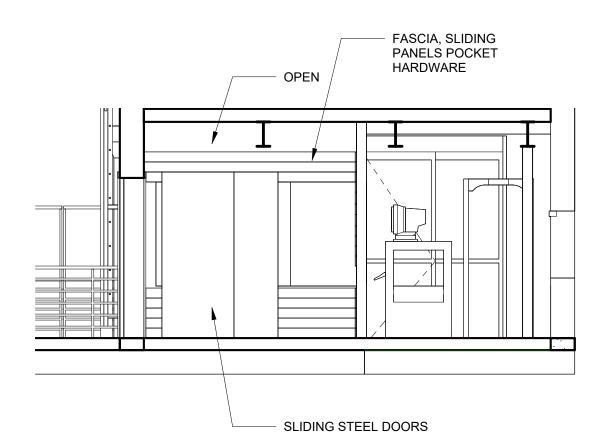

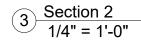



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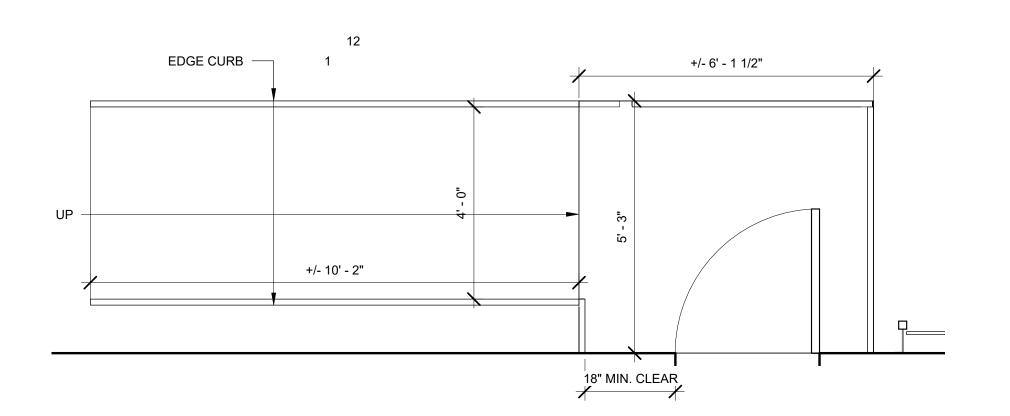
REVISIONS


NO. Date Description

SHEET TITLE


INTERIOR ELEVATIONS

A201



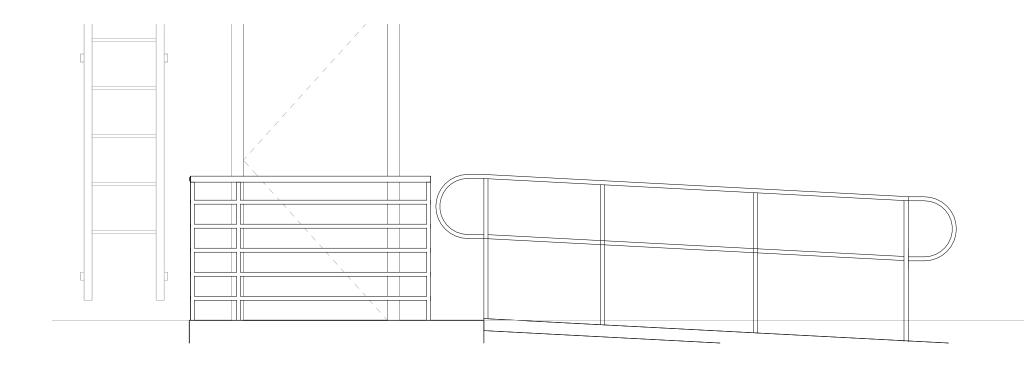

1) REAR RAMP, PLAN VIEW 1/2" = 1'-0"

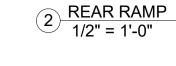



4 PHOTO EXISTING WALL @ ENTRANCE 1/8" = 1'-0"

<u>NOTES</u>

VERTICAL WALL MOUNT POLE

- AMERICAN FLAGPOLE, CONCORD INDUSTRIES, OR APPROVED EQUAL - STAINLESS STEEL WITH NO. 4 FINISH

- INCLUDE LIGHTING PROTECTION
- FACTORY FINISH COLOR BY ARCHITECT - SUBMIT SHOP DRAWINGS INDICATING MATERIAL CHARACTERISTICS, DETAILS OF CONSTRUCTION,

CONNECTIONS, AND RELATIONSHIP WITH ADJACENT CONSTRUCTION

BANNER & CANOPY LETTERING


- FASTSIGNS OF WALTHAM OR APPROVED EQUAL

- CANOPY METAL LETTERING: 1" THICK MIN. +/- 10" HEIGHT (1" LARGER THAN CANOPY FASCIA). - MATERIALS, ASSEMBLY AND ATTACHMENTS SHALL RESIST SNOW, WIND, SUCTION AND UPLIFT DESIGN LOADS IN ACCORDANCE WITH THE STATE BUILDING CODES, AND ANY LOCAL CODES, AT ANY POINT WITHOUT DAMAGE OR PERMANENT SET

- FRAME CONSTRUCTION: ASSEMBLIES SHALL BE CONSTRUCTED WITH SQUARE STEEL TUBING WITH THE MAIN FRAMING ELEMENTS WELDED. NESTED CONCEALED SLEEVE ASSEMBLIES WITH FLUSH FASTENERS WILL BE ACCEPTABLE FOR OTHER CONNECTIONS, PROVIDING REQUIRED STRENGTH IS MAINTAINED

- FRAME MEMBER SIZING, PLACEMENT, METHOD OF CONSTRUCTION AND ATTACHMENT, SHALL BE BY THE SIGN FABRICATOR

- COORDINATE INSTALLATION OF BANNER WITH POLE INSTALLATION - 5-YEAR WARRANTY

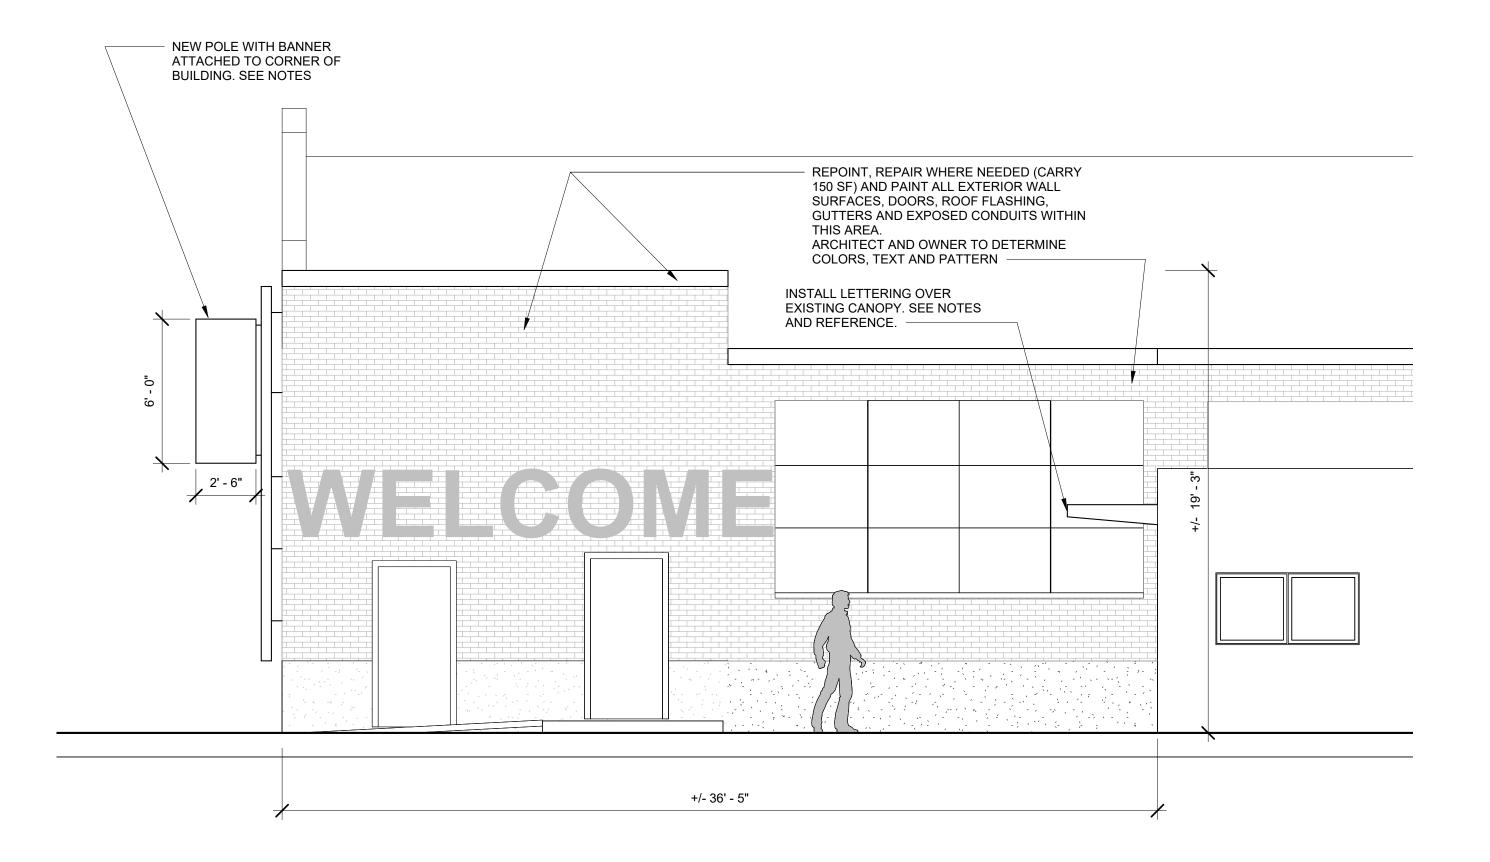

EXTERIOR WALL @ ENTRANCE NEW

3 WORK 1/4" = 1'-0"



5 CANOPY LETTERING FOR REFERENCE 1/4" = 1'-0"



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Drawn by: LAA Checked by: LA

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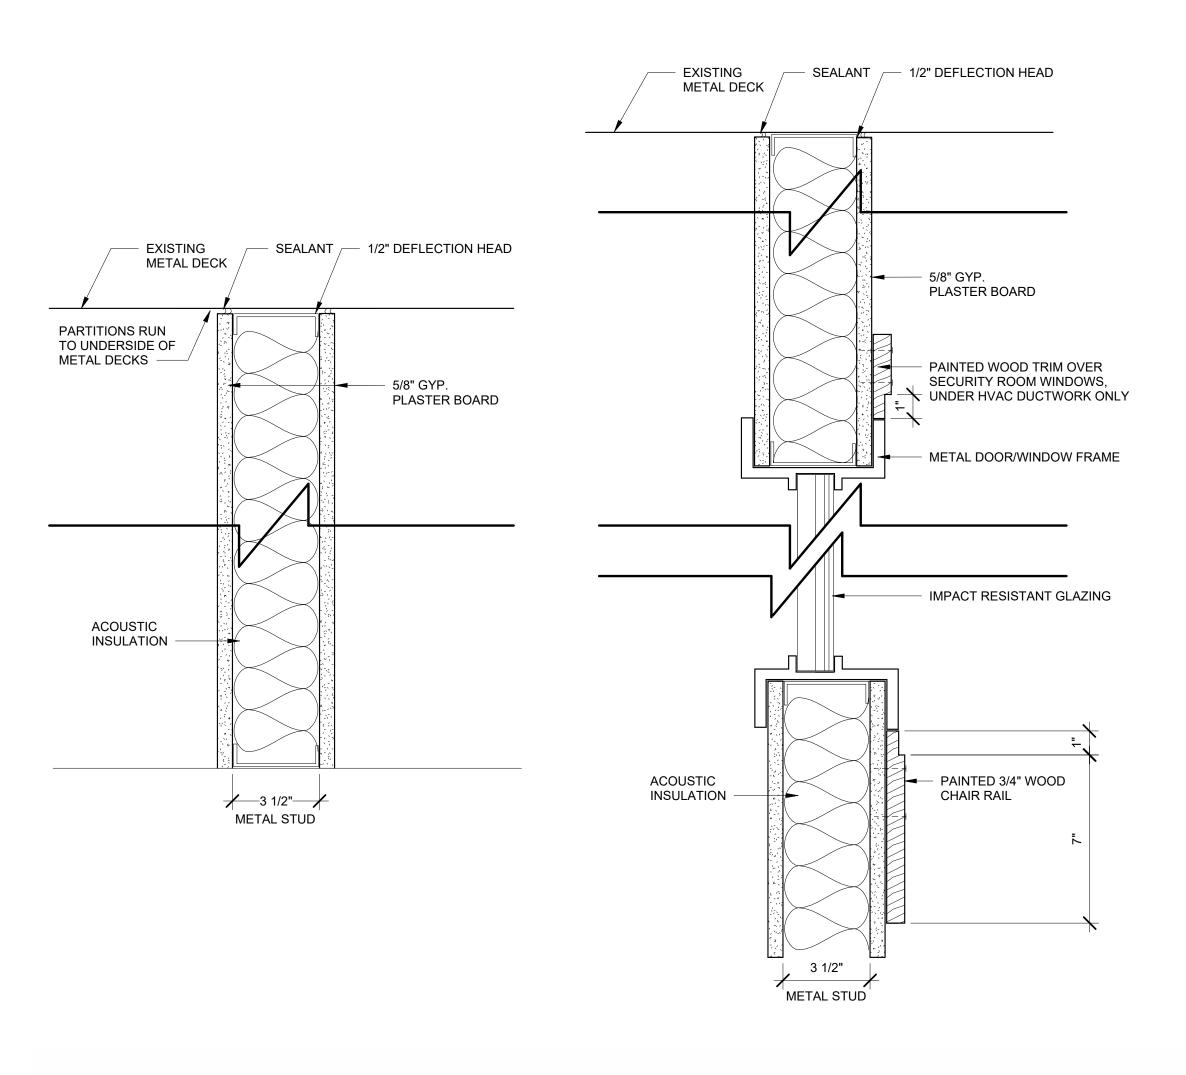



REVISIONS

NO. Date Description

SHEET TITLE

EXTERIOR DETAILS




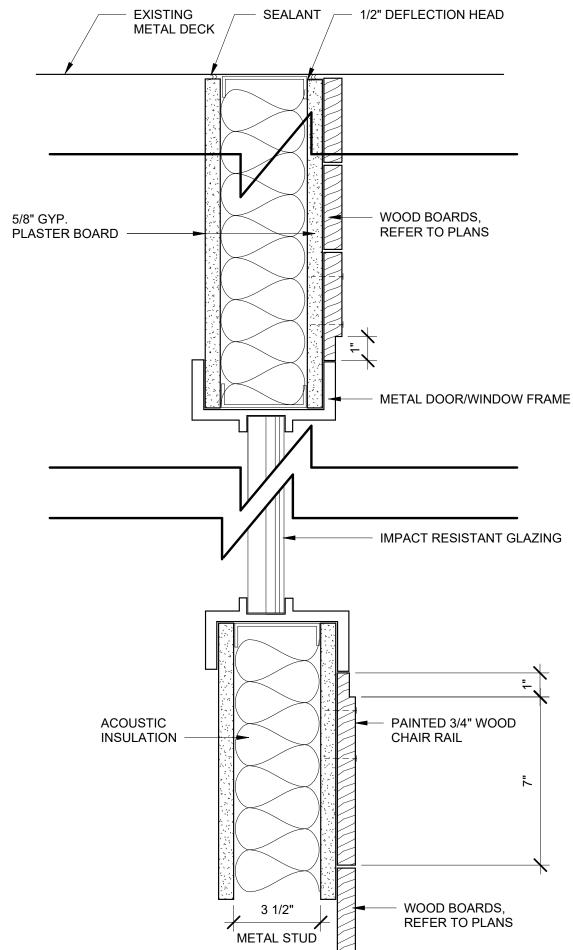

1 PARTITION DETAILS
3" = 1'-0"

FINISH SCHEDULE ROOM # FLOORING (1) BASE WALL CEILING (2) LEGEND ROOM NAME B1. VINYL BASE AT ALL GYPSUM WALLS B2. NO BASE AT EXPOSED MASONRY/CONCRETE WALLS VESTIBULE 100 RUBBER C1 B1, B2 W1 W1. PAINT EXISTING EXPOSED MASONRY/CONCRETE WALLS AND GYPSUM WALLS SCREENING 101 RUBBER W1 C W2. PAINT EXISTING GYPSUM WALLS W3. NEW PARTITIONS: PAINTED PLASTER W4. NEW PARTITIONS: PAINTED PLATER AND WOOD BOARDS SAFE AND SOUND 102 RUBBER B1, B2 W1 C. PAINT ALL SURFACES. SELECTED ELEMENTS OF DIFFERENT COLORS. TWO COLORS TOTAL. CEILING CLOUDS WHERE SHOWN. C1. PAINT ALL SURFACES ONE COLOR 103 W2, W4 С INTAKE RUBBER (1) RUBBER FLOORING: SPORTFLEX M, MONDO BY KIEFER USA, 6 MM OR APPROVED EQUAL. REFER TO SHEET A600 FOR SAMPLE DESIGN HALLWAY RUBBER B1, B2 W1, W3 С (2) CEILING CLOUDS: TECTUM SHAPES BY ARMSTRONG, 2" THICKNESS. COMBINATION OF 48", 36" AND 24". REFER TO RCP. CUSTOM COLORS SECURITY C1 105 RUBBER B1, B2 W1, W3 BY ARCHITECT. SEE SHEET A600 FOR CEILING PAINT REFERENCE. C1 OPEN OFFICE RUBBER W2, W4

2 FINISH SCHEDULE 1" = 1'-0"

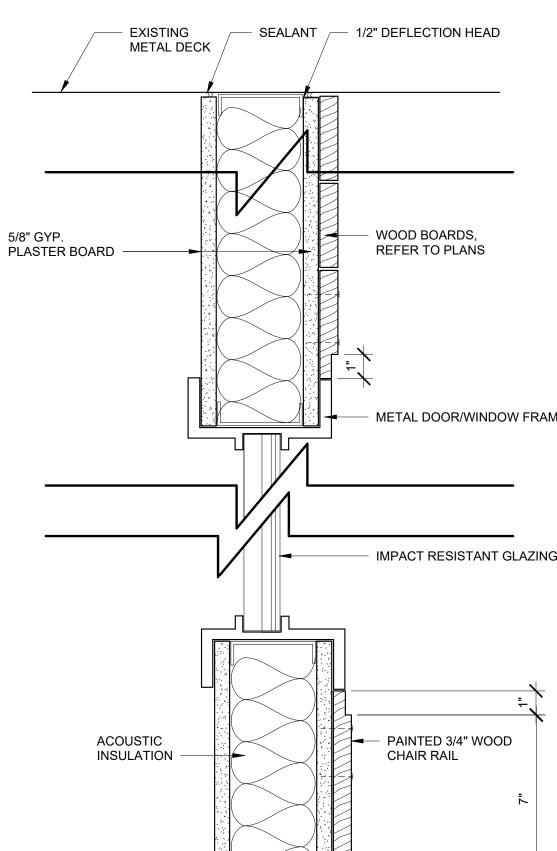



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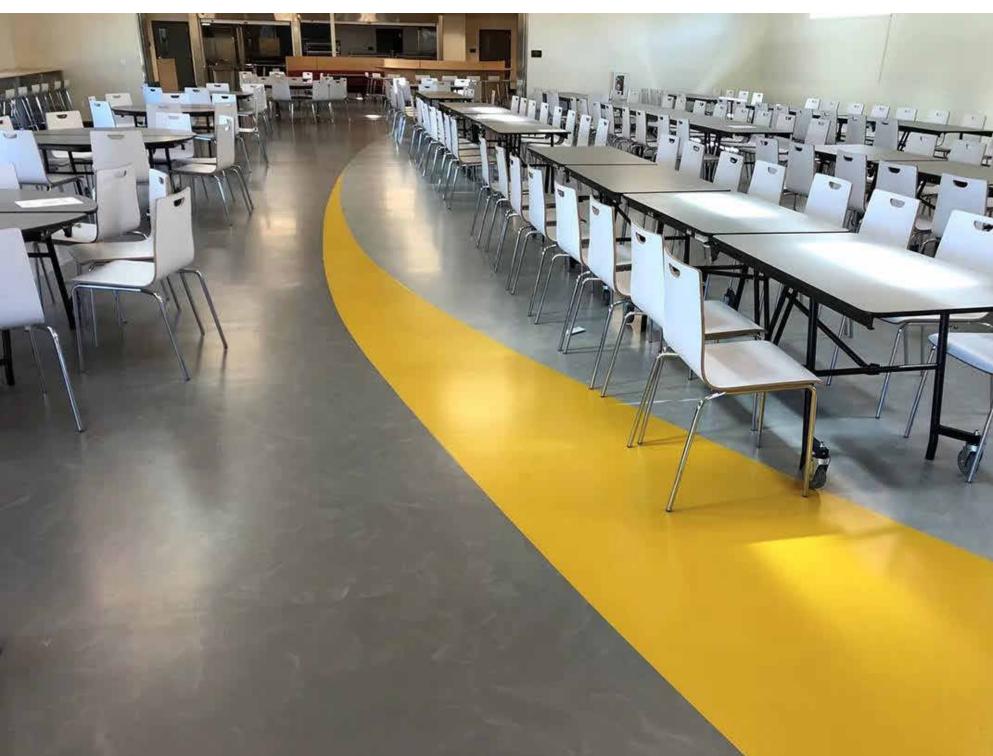
NO. Date Description

SHEET TITLE


PARTITIONS & FINISH SCHEDULE

FLOORING TREATMENT





CEILING PAINT CONCEPT

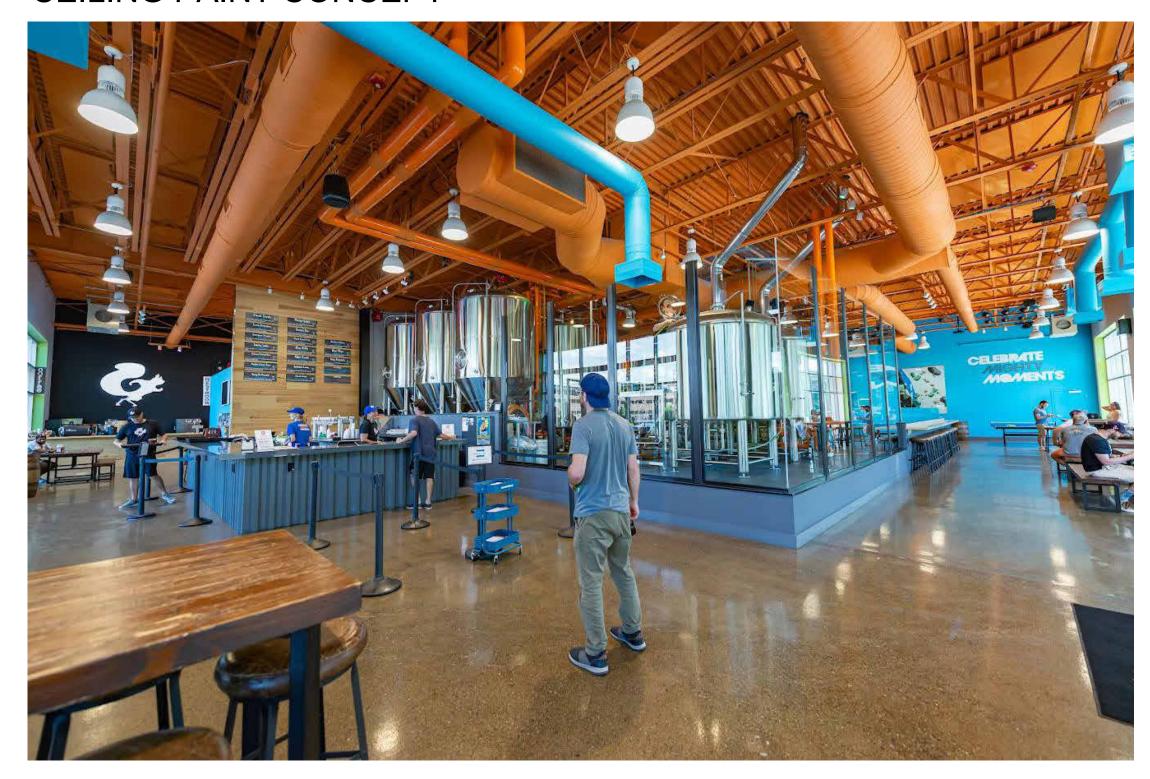





INTERIOR GRAPHIC



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PROJECT

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NO. Date Descrip

SHEET TITLE

INTERIOR FLOORING/ FURINTURE



	ONE-LINE SYMBOLS			ELEC	CTRICAL SYMBOLS (NOTE: NOT ALL SYMBOLS SYMBOLS USED WITH SYMBOLS	S INDICATED A MBOLS LEGENI	RE USED ON PLANS. COOD ACCORDINGLY.)	ORDINATE
YMBOL	DESCRIPTION	SYMBOL	DESCRIPTION	SYMBOL	DESCRIPTION	SYMBOL	DESCRIPTION	
	ONE-LINE		LIGHTING FIXTURES		POWER OUTLETS		FIRE	ALARM
•	GROUND CONNECTION	а	RECTANGULAR LUMINAIRE	\rightarrow	SINGLE RECEPTACLE, MOUNTED AT 18"AFF, UON	F	MANUAL PULL STATION	N, 48"AFF UON
<u></u>			A1 = FIXTURE TYPE a = CONTROL SWITCH INDICATOR	-	SHADED SYMBOL - ON EMERGENCY POWER		INITIATION DEVICE - CE NO DESIGNATION -	
	GENERATOR	<u>A1</u>	1 = CIRCUIT NUMBER	\Rightarrow	DUPLEX RECEPTACLE, MOUNTED AT 18"AFF, UON SHADED SYMBOL - ON EMERGENCY POWER		D - DUCT DETECTO	R
			EGRESS LIGHTING: 1. FULLY SHADED SYMBOL - 24 HOUR EGRESS FIXTURE			F _D	CO - CARBON MONI SC - COMBINATION	
	FUSE		2. HALF-SHADED SYMBOL - SWITCHED EGRESS FIXTURE	⇒ ⇒	DOUBLE DUPLEX RECEPTACLE, MOUNTED AT 18"AFF, UON SHADED SYMBOL - ON EMERGENCY POWER			
	CIRCUIT BREAKER		EGRESS LIGHTING SHALL BE CONNECTED TO EXISTING ON- SITE GENERATOR FOR 90 MINUTES OF BACKUP POWER.		SPECIAL RECEPTACLE - CONFIGURATION AS INDICATED	_	AUDIO AND VISUAL API	DI IANCE 84" /
	CINCOTT BINEARER		SITE GENERATOR FOR 90 MINOTES OF BACKUP FOWER.	-	MOUNTED 18"AFF, UON SHADED SYMBOL - ON EMERGENCY POWER	F	NO DESIGNATION - S - SPEAKER	
	METER	—О—	BARE LAMP - INDUSTRIAL / STRIP	•	SHADED SYMBOL - ON EMERGENCY POWER		5 - SPEAKER	
)			ROUND LUMINIARE	\ominus	DUPLEX OR DOUBLE DUPLEX RECEPTACLE, FLUSH,		VISUAL APPLIANCE, 84	
	CURRENT TRANSFORMER	Ю 🖵	WALL MOUNTED LUMINIARE	\bigoplus	CEILING MOUNTED, UON	F	NO DESIGNATION -	FIRE ALARM
		፟ ⊗	EXIT SIGN, CEILING OR WALL MOUNTED		DUPLEX OR DOUBLE DOUPLEX RECEPTACLE, FLUSH, FLOOR MOUNTED, UON			
	LIGHTNING ARRESTOR	1	EMERGENCY LIGHTING UNIT		FLOOK MOUNTED, OON	F	AUDIO APPLIANCE, 84" NO DESIGNATION -	
		⊶ □	POLE MOUNTED (HEADS AS INDICATED)	HJ	JUNCTION BOX, MOUNTED 18"AFF, UON	Z _s	S - SPEAKER	HOKN
	CAPACITOR			J	JUNCTION BOX, SURFACE MOUNTED ABOVE CEILING OR EXPOSED IN AREAS WITH EXPOSED CONDUIT, UON			
			SWITCHES & CONTROL OUTLETS		JUNCTION OR PULL BOX, FLUSH, FLOOR MOUNTED, UON	TS>	ALARM, VALVE SUPER	
	DISCONNECT SWITCH	\$3	SWITCHES - 48" AFF GANG LIGHT SWITCHES INDICATED ADJACENT TO EACH		JUNCTION OR FULL BOX, FLOOR, FLOOR MOUNTED, OUN	₹\$>	REMOTE ADDRESSABL	•
			OTHER IN A MULTI-GANG BOX AND MULTI-GANG FACEPLATE UNLESS OTHERWISE NOTED		TELECOMMUNICATION OUTLETS	R	FIRE ALARM DOOR HO	•
	GROUND FAULT PROTECTOR				TELEGOMMONIOATION COTEETS TELEPHONE DATA OUTLET, 54" AFF	FACP	FIRE ALARM CONTROL	
			2 = DOUBLE POLE, SINGLE THROW 3 = THREE WAY		DATA OUTLET, 18" AFF	FAAP	FIRE ALARM REMOTE	
	DRAWOUT CIRCUIT BREAKER		4 = FOUR WAY K = KEY OPERATED	4	VOICE/DATA OUTLET, 18" AFF	LOC	LOCAL OPERATOR CO	NSOLE
			C = MOMENTARY CONTACT, SPDT, CENTER OFF P = OFF PILOT LIGHT		SAME AS INDICATED ABOVE EXCEPT CIRCULAR			
	MAGNETIC MOTOR STARTER				SYMBOLS INDICATE CEILING MOUNTED AND SQUARE			
	MOTOR		LOW VOLTAGE ADDRESSIBLE SWITCH		SYMBOLS INDICATE FLUSH MOUNTED IN FLOOR	DE	RANCH CIRCL	
	WOTOK	<u>\$</u>	LIGHT SENSOR / PHOTO CONTROL		WLAN WIRELESS ADAPTER, CEILING MOUNTED UON		MINOR CINCO	
	CIRCUIT BREAKER PANELBOARD	<u> </u>	OCCUPANCY SENSOR, CEILING MOUNTED		WE'RE WINCELESS ABAILTER, SEIERRS WOOTTED SON	120V, 20A BRANCH CII		
	(H-X = 277/480V)	(P)	POWER PACK, CEILING MOUNTED		SUBSCRIPTS ON ELECTRICAL OUTLETS	12	.ov, zoa bixa	
	(L-X = 208/120V)	(PP)	UL924 RATED EM POWER PACK, CEILING MOUNTED	+44" =	NUMBER INDICATES MOUNTING HEIGHT AFF TO CENTER		HOMERUN LENGTH	MININUM
	TRANSFER SWITCH				LINE OF DEVICE.			
			CABLE TV & PUBLIC ADDRESS		ABOVE COUNTER - MOUNT DEVICE 6" ABOVE COUNTER OR 36" AFF AT WORKSTATIONS.		LESS THAN 100 FEET	FEET #12 AWG
	TRANSFORMER	ŀŢŷ	TELEVISION OUTLET 18" AFF UON	WP =	WEATHER PROOF - PROVIDE NEMA-3R RATED DEVICE OR			
		(\$)	CEILING MOUNTED SPEAKER, UON	VVI –	ENCLOSURE SUITABLE FOR EXTERIOR USE.		100 TO 150 FEET	#10 AW0
	OVERLOAD RELAY	H S	WALL MOUNTED SPEAKER, 7'-6" AFF, UON	TV =	TELEVISION DEDICATED - COORDINATE EXACT MOUNTING		450 70 050 5557	//o ANA/O
		AMP	SOUND CONTROL STATION		HEIGHT WITH EQUIPMENT INSTALLATION REQUIREMENTS.		150 TO 250 FEET	#8 AWG
	N.O. CONTACT	₩	VOLUME CONTROL MOUNTED 48" AFF, UON	EP =	EXPLOSION PROOF PER NEC 500 CLASS I, DIVISION 1.	GR	EATER THAN 250 FEET	#6 AWG
		K	INTERCOM STATION MOUNTED 48" AFF, UON	EX =	EXISTING DEVICE OR EQUIPMENT.		ENTER THAT 2001 EET	11071110
	N.C. CONTACT		DOWED DISTRIBUTION	EM =	CONNECTED TO AN EMERGENCY POWER SOURCE.			E CONDUCTOR SIZES INDICAT ER AND SYSTEMS DRAWINGS
	KIRK KEY		PANELBOARD PANELBOARD	D =	DEDICATED - PROVIDE ENGRAVED COVER PLATE.	CIRC	UIT. HOMERUN LENGTH 1	TO INCLUDE BO
	NINK KE I		MOTOR CONTROL CENTER	H =	HOSPITAL GRAGE.	SIZE	TO MEET THE NEC FOR IN	ICREASE CON
	LAMP		DISTRIBUTION POWER PANEL OR SWITCHBOARD	T =	TAMPER RESISTANT.			
			ELECTRICAL CABINET - CONFIGURATION AS INDICATED	U =	CONNECTED TO UPS SYSTEM.			
_	- 70		PULL BOX, SIZED IN ACCORDANCE WITH NEC	IG =	ISOLATED GROUND.			
-STATE		РВ	ARTICLE 314 REQUIREMENTS OR LARGER, UON	GFI =	OUTLET WITH GFCI PROTECTION.			
ER 			DISCONNECT SWITCH	011 -	OUTLET WITH GIFT CIFTOTE CHON.			
			MOTOR STARTER WITH NEMA SIZE AS INDICATED					
			MOTOR OR EQUIPMENT CONNECTION TRANSFORMER					
		T	TVANOI ONWER					
			GROUNDING & LIGHTNING PROTECTION					
		•	AIR TERMINAL - REFER TO DETAILS					
		 	GROUND ROD	PNL	PANELBOARD AND CIRCUIT AS INDICATED. CONTRACTOR			
			EXOTHERMIC WELD TYPE GROUNDING CONNECTION	<u>PNL</u> 1,3,5	SHALL PROVIDE CONDUIT AND WIRES PER 2016 CEC TO CONNECT THE CIRCUIT(S) AS INDICATED ON THE PLAN.			
			WALL MOUNTED GROUNDING BUSBAR					
			CONDUIT / WIRING					
		0	CONDUIT UPWARD CONDUIT DOWNWARD					
		•	CONDUIT DOWNWARD CONDUIT CONCEALED IN CEILING OR WALL					
			CONDUIT CONCEALED IN CEILING OR WALL CONDUIT EXPOSED					
			CONDUIT CONCEALED BELOW SLAB					

120V, 20A BRA	NCH CIRCUITS	277V, 20A BRANCH CIRCUITS					
HOMERUN LENGTH	MININUM CONDUCTOR SIZE	HOMERUN LENGTH	MININUM CONDUCTOR SIZ				
LESS THAN 100 FEET	#12 AWG COPPER	LESS THAN 250 FEET	#12 AWG COPPER				
100 TO 150 FEET	#10 AWG COPPER	250 TO 350 FEET	#10 AWG COPPER				
150 TO 250 FEET	#8 AWG COPPER	GREATER THAN 350 FEET	#8 AWG COPPER				
GREATER THAN 250 FEET	#6 AWG COPPER						

NO DESIGNATION - SMOKE DETECTOR D - DUCT DETECTOR

CO - CARBON MONIXIDE DETECTOR SC - COMBINATION SMOKE AND CO

INITIATION DEVICE - CEILING MOUNT, DESIGNATIONS AS FOLLOWS:

AUDIO AND VISUAL APPLIANCE, 84" AFF. DESIGNATIONS AS FOLLOWS: NO DESIGNATION - HORN

VISUAL APPLIANCE, 84" AFF. DESIGNATIONS AS FOLLOWS:

AUDIO APPLIANCE, 84" AFF. DESIGNATIONS AS FOLLOWS: NO DESIGNATION - HORN S - SPEAKER

ALARM, VALVE SUPERVISORY TAMPER SWITCH

FIRE ALARM REMOTE ANNUNCIATOR PANEL

ALARM, SPRINKLER SYSTEM, WATER FLOW SWITCH

REMOTE ADDRESSABLE RELAY (DPDT CONTACTS)

NOTE: PROVIDE CONDUCTOR SIZES INDICATED ON ABOVE SCHEDULE UNLESS OTHERWISE NOTED INDICATED ON LIGHTING POWER AND SYSTEMS DRAWINGS HOMERUN JUNCTION BOX TO BE WITHIN 10' OF LAST DEVICE CONNECTED TO CIRCUIT. HOMERUN LENGTH TO INCLUDE BOTH HORIZONTAL AND VERTICAL ROUTING DISTANCES. INCREASE CONDUIT SIZE TO MEET THE NEC FOR INCREASE CONDUCTOR SIZES

ELECTRICAL SHEET LIST						
Sheet Number	Sheet Name					
E001	GENERAL SHEET					
E100	FIRST FLOOR - DEMOLITION PLAN					
E101	FIRST FLOOR - POWER AND LIGHTING PLAN					
E600	SPECIFICATION					
Grand total: 4						



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PROJECT

112 Southampton Entryway Redesign

Project Status:100% CD Issue Date:05/26/2023 GDT Project Number:23083 Drawn by:B.CHEE Checked by:B.CHEE

CLIENT


Boston Public Health Commission

REVISIONS

NO. Date Description

SHEET TITLE

GENERAL SHEET

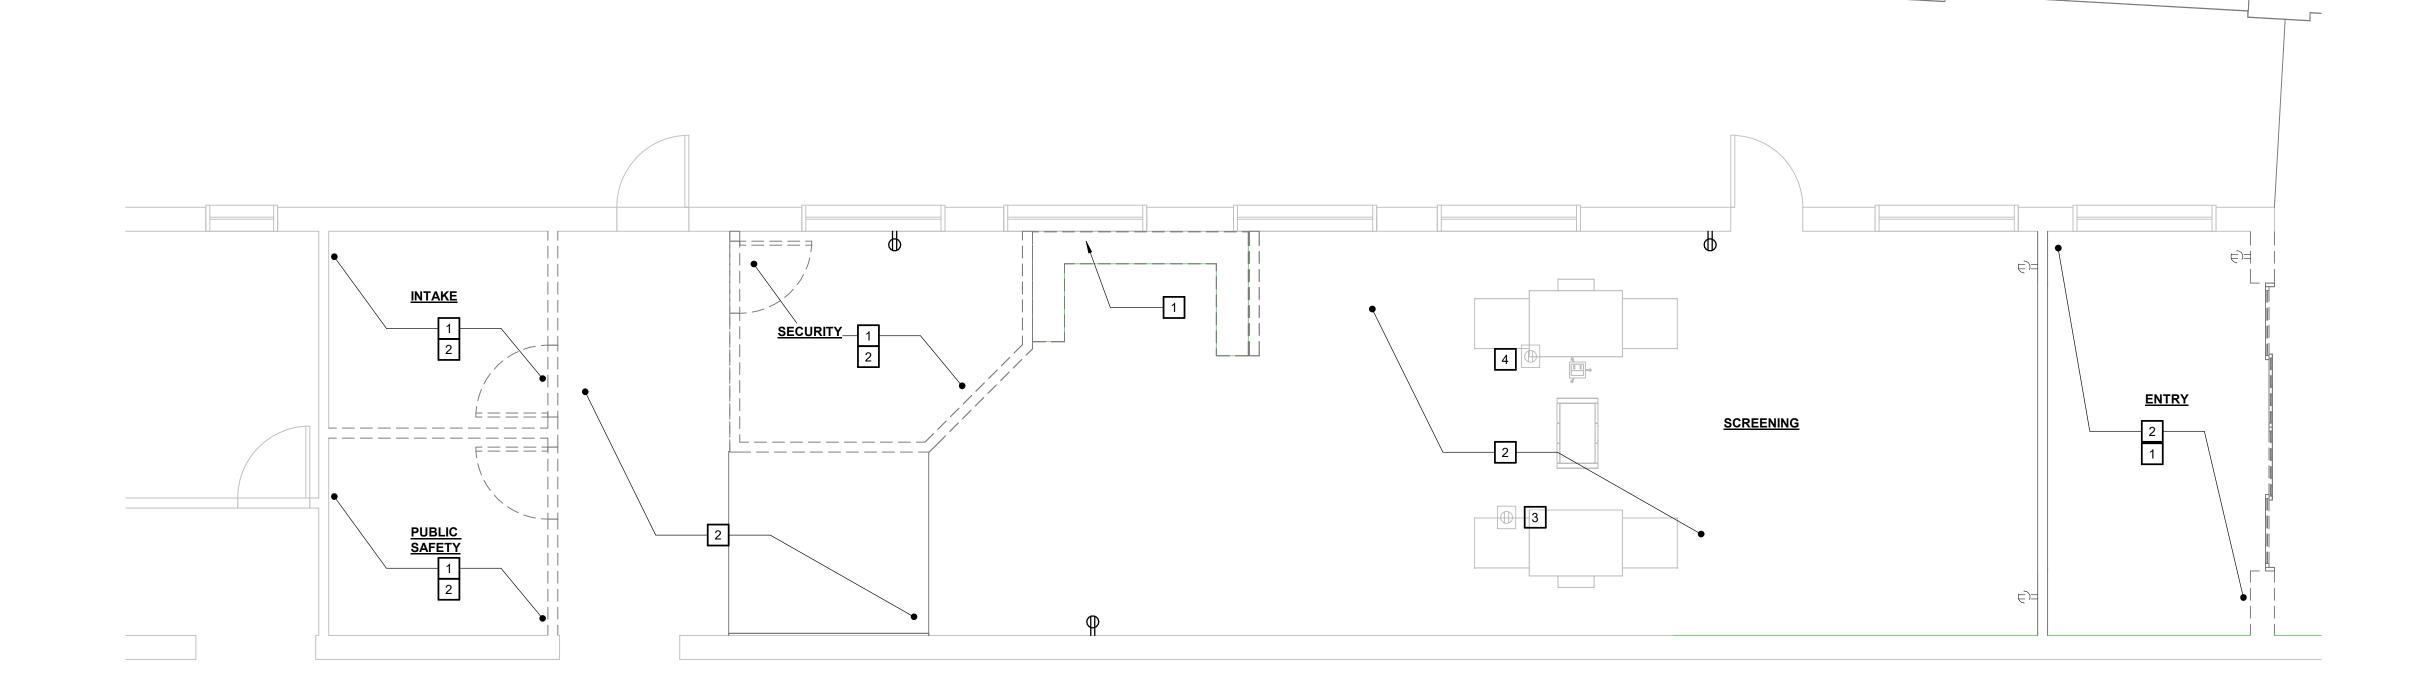

1 FIRST FLOOR PLAN - DEMOLITION E100 SCALE: 1/4" = 1'-0"

DEMOLITION GENERAL NOTES:

- 1. THE CONTRACTOR SHALL VISIT THE SITE AND BECOME FAMILIAR WITH THE EXISTING CONDITIONS. MAKE MODIFICATIONS TO EXISTING ELECTRICAL EQUIPMENT AS NECESSARY OR REQUIRED BY THESE ALTERATIONS AND ADDITIONS. THE DRAWINGS DO NOT INDICATE ALL SUCH ELECTRICAL EQUIPMENT.
- 2. DISCONNECT AND REMOVE EXISTING ELECTRICAL MATERIALS AND EQUIPMENT WHICH ARE RENDERED OBSOLETE BY THESE ALTERATIONS AND ADDITIONS.
- DISCONNECT, REMOVE AND RELOCATE EXISTING ELECTRICAL EQUIPMENT WHICH INTERFERE WITH OBSTRUCT OR ARE OBSTRUCTED BY THESE ALTERATIONS OR ADDITIONS.
- 4. ITEMS TO REMAIN SHALL MAINTAIN FUNCTION. EXTEND UTILITIES AS NECESSARY TO CONTINUE OPERATION.
- 5. MAINTAIN UNINTERRUPTED SERVICES TO ALL AREAS REQUIRED BY OWNER DURING THESE ALTERATION AND ADDITIONS.
- 6. EXISTING MATERIAL AND EQUIPMENT REMOVED UNDER THIS CONTRACT SHALL REMAIN THE PROPERTY OF THE OWNER AND UNLESS REFUSED SHALL BE STORED OR DISPOSED OF AS DIRECTED. EQUIPMENT DAMAGED DURING REMOVAL UNDER THIS CONTRACT SHALL BE REPAIRED OR REPLACED.
- 7. EXISTING MATERIAL AND EQUIPMENT BEING REFUSED BY OWNER SHALL BE DISPOSED OF IN A PROPER MANNER. SEE SPECIFICATIONS FOR REQUIREMENTS.

KEYNOTES:

- DISCONNECT AND REMOVE (E) ELECTRICAL DEVICES IN THIS AREA INCLUDING BUT NOT LIMITED TO RECEPTACLES, LIGHT FIXTURES, FIRE ALARM, SMOKE DETECTOR AND ETC THAT ARE MOUNTED TO DEMOLISHED WALL AND DEMOLISHED CEILING. DEVICES ARE NOT SHOWN ON PLANS, CONTRACTOR SHALL FIELD VERIFY SITE CONDITION PRIOR TO BEGIN OF WORK.
- DISCONNECT AND REMOVE LIGHT FIXTURES. PROTECT AND REUSE (E) LIGHTING CIRCUIT FOR NEW LIGHT FIXTURE.
- 3 EXISTING TO REMAIN AND PROVIDE EXTENSION CORD TO EXTENT POWER TO X-RAY AND SCREEN LOCATION.
- 4 EXISTING TO REMAIN AND PROTECTED.



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PROJECT

112 Southampton Entryway Redesign

Project Status:100% CD Issue Date:05/26/2023 GDT Project Number:23083 Drawn by:B.CHEE Checked by:B.CHEE

CLIENT

Boston Public Health Commission

STAMP

REVISIONS


NO. Date Description

SHEET TITLE


FIRST FLOOR - DEMOLITION PLAN

E100

LIGHTING FIXTURE SCHEDULE										
TYPE	DESCRIPTION	MOUNTING	LUMENS	COLOR TEMP	CRI	VOLTAGE	INPUT LOAD	MANUFACTURER	CATALOG NUMBER	NOTES
D1	4" RECESSED DOWN LIGHT W/ MATTE DIFFUSE AND VERY WIDE DISTRIBUTION	RECESSED	900 LM	3500K		MVOLT	10 W	MAXLUME	HH4-LED SERIES	
P1	6" X 4' LINEAR FIXTURE W/ SLIGHT UPLIGHT WIDE CURVE LENS W/ MOTION & DAYLITE COMBO SENSOR	AIR CRAFT CABLE @ 8' AFF	UP - 500 LM/FT & DOWN - 600 LM/FT	3500K		MVOLT	40 W	LITECONTROL	SNAP FLAIR SERIES	
P1E	6" X 4' LINEAR FIXTURE W/ SLIGHT UPLIGHT WIDE CURVE LENS W/ MOTION & DAYLITE COMBO SENSOR + 90 MINS EM BATTERY	AIR CRAFT CABLE @ 8' AFF	UP - 500 LM/FT & DOWN - 600 LM/FT	3500K		MVOLT	40 W	LITECONTROL	SNAP FLAIR SERIES	
P2	6" X 4' LINEAR FIXTURE W/ SLIGHT UPLIGHT WIDE CURVE LENS W/ MOTION & DAYLITE COMBO SENSOR	AIR CRAFT CABLE @ 8' AFF	UP - 500 LM/FT & DOWN - 600 LM/FT	3500K		MVOLT	80 W	LITECONTROL	SAE 101 SERIES	
P2E	6" X 4' LINEAR FIXTURE W/ SLIGHT UPLIGHT WIDE CURVE LENS W/ MOTION & DAYLITE COMBO SENSOR + 90 MINS EM BATTERY	AIR CRAFT CABLE @ 8' AFF	UP - 500 LM/FT & DOWN - 600 LM/FT	3500K		MVOLT	80 W	LITECONTROL	SAE 101 SERIES	
X1	EDGE LITE EXIT SIGN, PROVIDE NUMBER OF FACES AND CHEVRONS AS SHOWN ON PLANS.	CEILING	RED LETTER	-		MVOLT	5 W		LQM-S-W-3-R-120/277-ELN-SD LRP SERIES	

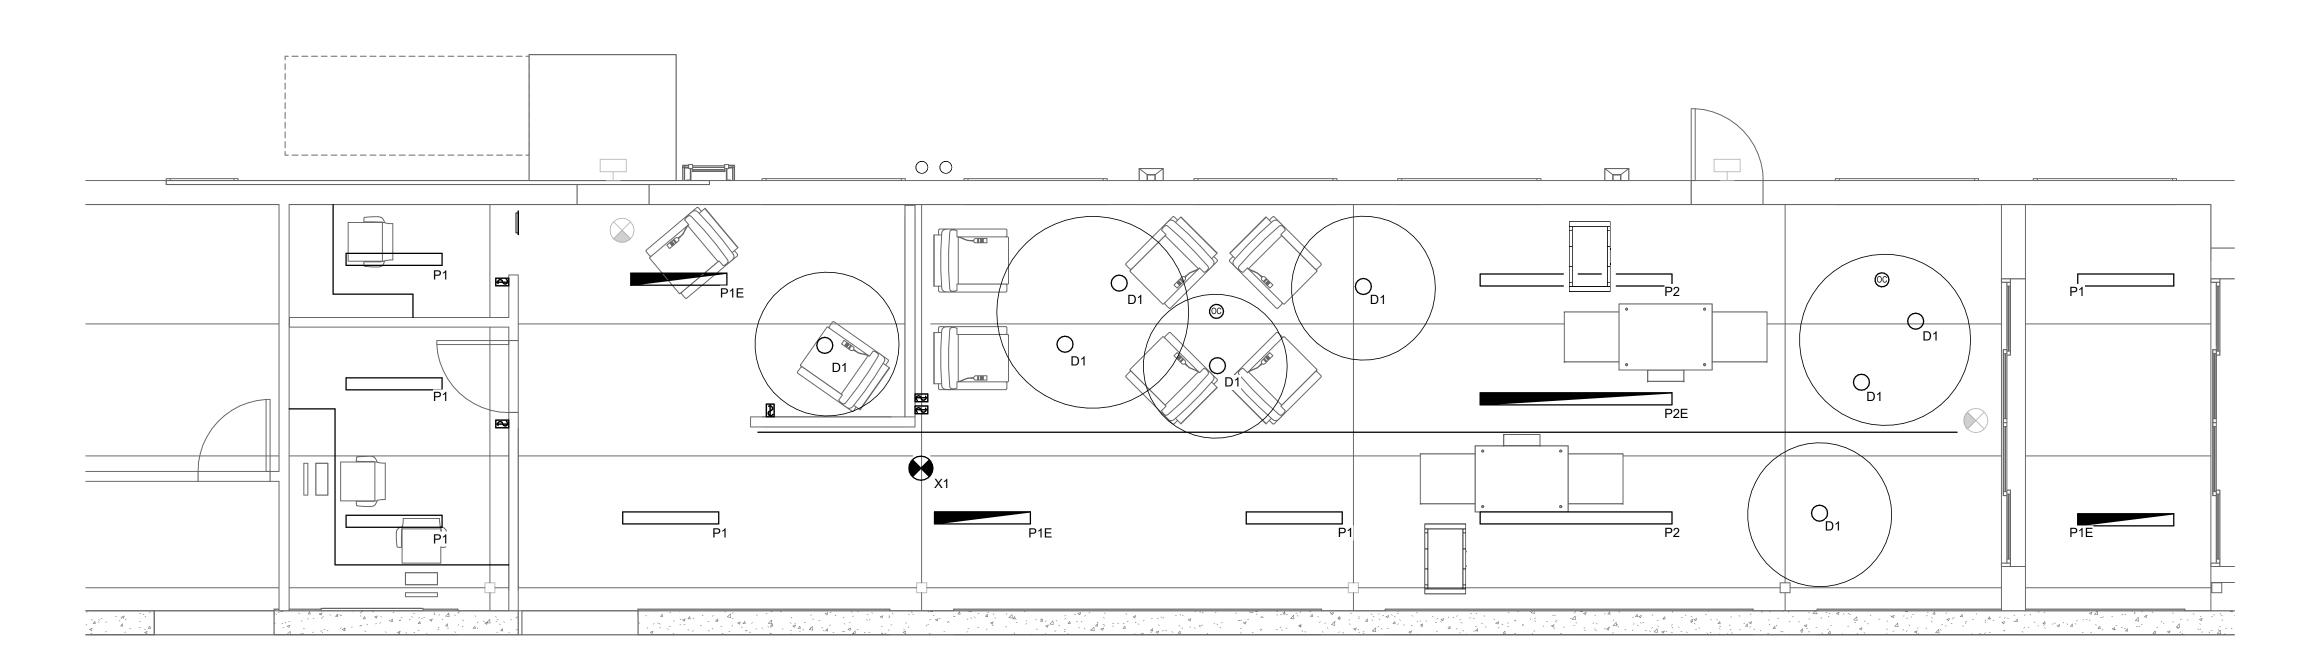

2 FIRST FLOOR LIGHTING PLAN E101 SCALE: 1/4" = 1'-0"

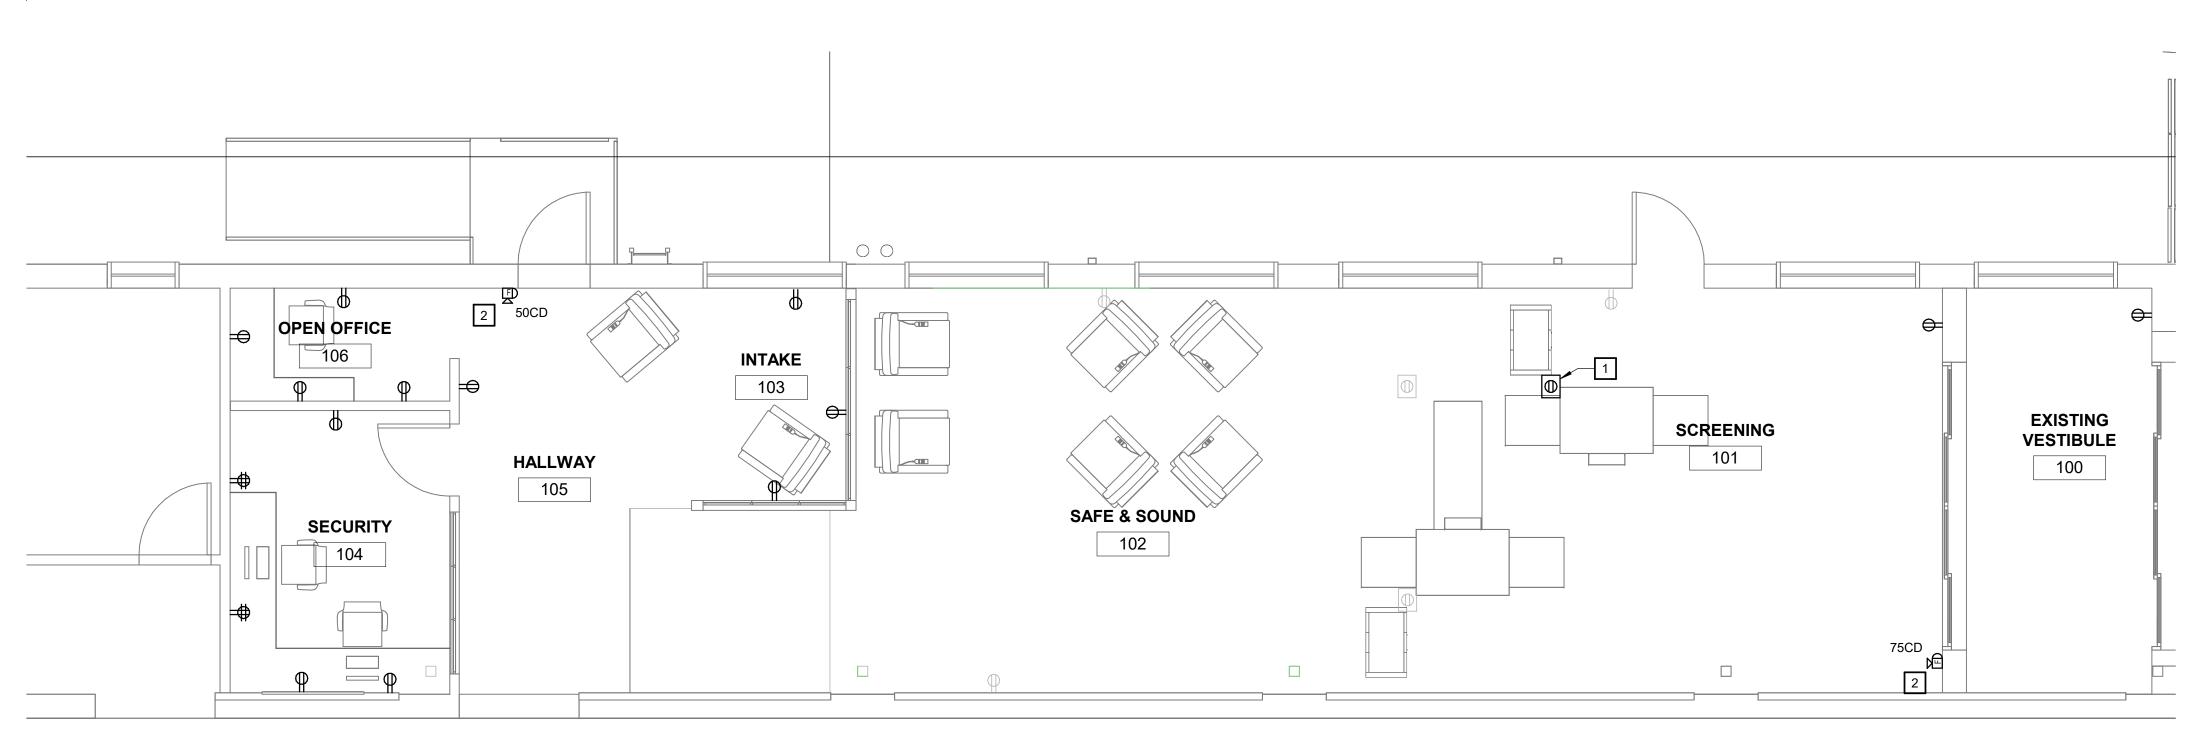

1 FIRST FLOOR POWER PLAN E101 SCALE: 1/4" = 1'-0"

GENERAL NOTES

- CONTRACTOR SHALL FIELD VERIFY ALL EXISTING CIRCUIT AND WIRING PRIOR TO DEMOLITION AND INSTALLATION. COORDINATE WITH ENGINEER AND OWNER FOR ANY CONFLICT FOUND PRIOR TO INSTALLATION.
- DO NOT ROUTE BRANCH CIRCUITS OR FEEDERS IN OR BELOW CONCRETE FLOORS (UON) UNLESS OTHERWISE NOTED.
- PROVIDE FIRE SEALS FOR INSERTS, SLEEVES, AND CONDUIT THROUGH FIRE WALLS, CEILINGS, AND FLOORS PER SPECIFICATION AND DETAIL 1/E604.
- PROVIDE SEPARATE GROUNDED NEUTRAL CONDUCTOR FOR EACH CIRCUIT, MULTI WIRED CIRCUITS WITH SHARED GROUNDED NEUTRAL CONDUCTORS ARE NOT ALLOWED.
- PROVIDE RIGID STEEL CONDUIT OF ALL EXPOSED EXTERIOR FEEDERS AND BRANCH CIRCUITS.
- NO PIPING, DUCTS, LEAK PROTECTION APPARATUS, OR OTHER EQUIPMENT FOREIGN TO THE ELECTRICAL INSTALLATION SHALL BE LOCATED IN THE DEDICATED ELECTRICAL SPACE. REPORT ANY CONFLICT TO THE GENERAL CONTRACTOR AND ARCHITECT.
- PROVIDE EMERGENCY CIRCUITS IN SEPARATE CONDUITS; DO NOT COMBINE WITH NORMAL OR STANDBY WIRING.
- CONCEAL ALL WIRING IN WALLS AND, COLUMNS, AND CEILING SPACE IN FINISHED SPACES.
- PROVIDE RIGID STEEL CONDUITS FROM FLOOR TO 12'-0" ABOVE FINISHED FLOOR IN EXPOSED AREAS, ELECTRICAL METALIC TUBING ALLOWED ABOVE 12'-0" FINISHED FLOOR.
- PROVIDE CAST METAL DEVICE BOXES MINIMUM 2" DEEP FOR TERMINATION OF RIGID STEEL CONDUITS BELOW 12'-0" OF FINISHED FLOOR.
- 11. PROVIDE CONDUIT SEALS AT WALL PENETRATIONS THROUGH WALLS, CEILINGS, AND FLOORS BETWEEN SPACES OF DIFFERENT TEMPERATURES AND OR HUMIDITY LEVELS.
- 12. ROUTE ALL HORIZONTAL CONDUITS STRAIGHT WITH BUILDING STRUCTURAL MEMBERS ABOVE BOTTOM CORD OF JOIST.
- NUMBERS ON ALL DEVICE COVERS. WRITE PANEL AND CIRCUIT NUMBER ON INSIDE OF DEVICE PLATE BOX COVERS WITH PERMANENT MARKER.

PROVIDE LABELS WITH PANEL AND CIRCUIT

- WRITE PANEL AND CIRCUIT OF ALL CIRCUITS RUNNING THROUGH J-BOX ON OUTSIDE COVERS WITH PERMANENT MARKER.
- PROVIDE CONDUIT AND WIRING TO EXTEND EXISTING CIRCUITS TO NEW LIGHT FIXTURE WITH MODIFY LIGHTING CONTROL.
- NEW RECEPTACLES AND EQUIPMENT IN REMODEL SPACE SHALL BE CONNECTING TO EXISTING PANELBOARD P12.

KEYNOTES:

- PROVIDE POWER AND DATA FLOORBOX FOR X-RAY AND METAL DETECTOR. COORDINATE FINAL LOCATION WITH X-RAY AND METAL DETECTOR INSTALLER PRIOR TO INSTALLATION.
- 2 EXTEND AND RECONNECT TO EXISTING FA VISUAL AND NOTIFICATION CIRCUIT.



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FIRST FLOOR - POWER AND LIGHTING PLAN

E101

GENERAL ELECTRICAL REQUIREMENTS

GENERAL - DESCRIPTION

THIS SECTION INCLUDES MATERIALS, INSTALLATION, AND TESTING OF THE ELECTRICAL SYSTEM.

SUBMITTALS

SUBMIT SHOP DRAWINGS IN ACCORDANCE WITH ARCHITECT/OWNER

- IN SUBMITTED CATALOG CUTS, CROSS OUT ITEMS SHOWN THAT ARE NOT PERTINENT TO THIS PROJECT. WHERE CATALOG CUTS LIST MANUFACTURER'S STANDARD OPTIONS, CROSS OUT THOSE OPTIONS NOT INTENDED TO BE PROVIDED AND CLEARLY HIGHLIGHT THOSE OPTIONS
- THAT ARE TO BE PROVIDED. SUBMIT ELECTRICAL SERVICE CHANGES WORK PROCEDURE.

REGULATORY AGENCIES AND STANDARDS

ELECTRICAL WORK SHALL COMPLY WITH THE LATEST NEC CODE AND ENERGY CODE PER LOCAL AUTHORITY HAVING JURISDICTION.

MATERIALS, APPLIANCES, EQUIPMENT, AND DEVICES SHALL CONFORM TO THE APPLICABLE UL STANDARDS. THE LABEL OF, OR LISTING BY, UL IS REQUIRED FOR ALL ELECTRICAL EQUIPMENT.

GENERAL: USE EQUIPMENT, MATERIALS, AND WIRING METHODS SUITABLE FOR THE TYPES OF LOCATIONS IN WHICH THEY ARE LOCATED AS DEFINED

- **DEFINITIONS OF TYPES OF LOCATIONS:** DRY LOCATIONS: INDOOR AREAS WHICH DO NOT FALL WITHIN THE DEFINITIONS BELOW FOR WET, DAMP, HAZARDOUS, OR CORROSIVE LOCATIONS AND WHICH ARE NOT OTHERWISE DESIGNATED IN THE DRAWINGS
- WET LOCATIONS: LOCATIONS EXPOSED TO THE WEATHER. WHETHER UNDER A ROOF OR NOT, UNLESS OTHERWISE DESIGNATED IN THE DRAWINGS.
- DAMP LOCATIONS: SPACES WHOLLY OR PARTIALLY UNDERGROUND UNLESS OTHERWISE DESIGNATED IN THE

- SIMILAR MATERIALS AND EQUIPMENT SHALL BE THE PRODUCT OF A SINGLE MANUFACTURER.
- PROVIDE ONLY PRODUCTS WHICH ARE NEW, UNDAMAGED, AND IN THE ORIGINAL CARTONS OR CONTAINERS.
- MATERIALS AND EQUIPMENT SHALL BE THE STANDARD PRODUCTS OF MANUFACTURERS REGULARLY ENGAGED IN THE PRODUCTION OF SUCH MATERIAL AND SHALL BE THE MANUFACTURER'S CURRENT DESIGN. MATERIALS AND EQUIPMENT SHALL BE SUITABLE FOR STORAGE,
- INSTALLATION, AND OPERATION AT AN AMBIENT TEMPERATURE OF 0°C TO 40°C EXCEPT WHERE MORE STRINGENT CONDITIONS ARE STATED IN INDIVIDUAL EQUIPMENT SPECIFICATIONS.
- ELECTRICAL EQUIPMENT AND PANELS SHALL BE FACTORY FINISHED WITH MANUFACTURER'S STANDARD PRIMER AND ENAMEL TOPCOATS, UNLESS STATED OTHERWISE IN THE INDIVIDUAL EQUIPMENT SPECIFICATIONS. PROVIDE 1 PINT OF THE EQUIPMENT MANUFACTURER'S TOUCHUP PAINT PER 500 SQUARE FEET OF PAINTED SURFACE FOR REPAIR OF DAMAGED ENAMEL TOPCOATS.

EXECUTION - INSTALLATION

- UNLESS OTHERWISE NOTED, REMOVE EXISTING ELECTRICAL MATERIALS AND EQUIPMENT FROM AREAS INDICATED FOR DEMOLITION OR WHERE EQUIPMENT IS RELOCATED. REMOVE MATERIALS NO LONGER USED, SUCH AS STUDS, STRAPS, AND CONDUITS. REMOVE OR CUT OFF CONCEALED OR EMBEDDED CONDUIT, BOXES, OR OTHER MATERIALS AND EQUIPMENT TO A POINT AT LEAST 3/4 INCH BELOW THE FINAL FINISHED SURFACE. REMOVE EXISTING UNUSED WIRES.
- REPAIR AFFECTED SURFACES TO CONFORM TO THE TYPE, QUALITY, AND FINISH OF THE SURROUNDING SURFACE.

REMOVAL OR RELOCATION OF MATERIALS AND EQUIPMENT

UNLESS OTHERWISE NOTED, REMOVE EXISTING ELECTRICAL MATERIALS AND EQUIPMENT FROM AREAS INDICATED FOR DEMOLITION OR WHERE EQUIPMENT IS RELOCATED. REMOVE MATERIALS NO LONGER USED, SUCH AS STUDS, STRAPS, AND CONDUITS. REMOVE OR CUT OFF CONCEALED O EMBEDDED CONDUIT, BOXES, OR OTHER MATERIALS AND EQUIPMENT TO A POINT AT LEAST 3/4 INCH BELOW THE FINAL FINISHED SURFACE. REMOVE EXISTING UNUSED WIRES.

REPAIR AFFECTED SURFACES TO CONFORM TO THE TYPE, QUALITY, AND FINISH OF THE SURROUNDING SURFACE.

NAMEPLATES

- MARK EACH INDIVIDUAL PANELBOARD, MOTOR CONTROLLER, DISCONNECT SWITCH, TIMER, RELAY, AND CONTACTOR TO IDENTIFY EACH ITEM WITH ITS RESPECTIVE SERVICE OR FUNCTION.
- PROVIDE RED NAMEPLATES DESIGNATED "EMERGENCY" ON ALL THE FOLLOWING ITEMS SERVED BY THE EMERGENCY POWER SYSTEM:
 - MOTOR VFD DISCONNECT SWITCHES.
- REFRIGERANT DETECTION SYSTEM
- PROVIDE THE FOLLOWING LISTED OUTLETS AND EQUIPMENT WITH ENGRAVED LABEL LISTING THE PANEL DESIGNATION AND CIRCUIT
 - PROVIDE A NAMEPLATE INSIDE THE DOOR OF EACH PANELBOARD LISTING ITS DESIGNATION, VOLTAGE, AND FEEDER CIRCUIT
 - PROVIDE NAMEPLATES WITH ENGRAVED LETTERING NOT LESS THAN 1/4 INCH HIGH. USE BLACK-ON-WHITE LAMINATED PLASTIC, ATTACHED WITH RIVETS OR SHEET METAL SCREWS. DO NOT USE EMBOSSED PLASTIC ADHESIVE TAPE.

WARNING SIGNS

- INSTALL MARKINGS, IDENTIFICATIONS, WARNING, CAUTION, OR INSTRUCTION SIGNS WHERE REQUIRED BY NEC, NFPA 70E, AND NFPA 79 PARAGRAPH 4.5.1, WHERE INDICATED, OR WHERE REASONABLY REQUIRED TO ASSURE SAFE OPERATION AND MAINTENANCE OF ELECTRICAL SYSTEMS AND OF THE ITEMS TO WHICH THEY CONNECT.
- THE DESIGN OF SAFETY SIGNS AND LABELS SHALL CONFORM TO ANSI Z535.4. SWITCHGEAR, PANELBOARDS, INDUSTRIAL CONTROL PANELS, MOTOR CONTROL CENTER, AND VFD SHALL BE FIELD MARKED TO WARN QUALIFIED PERSONS OF POTENTIAL ELECTRIC ARC HAZARDS. THE MARKING SHALL BE LOCATED SO AS TO BE CLEARLY VISIBLE TO QUALIFIED PERSONS BEFORE EXAMINATION, ADJUSTMENT, SERVICING, OR MAINTENANCE OF THE EQUIPMENT, IN CONFORMANCE WITH NEC ARTICLE
- INSTALL ENGRAVED PLASTIC-LAMINATED INSTRUCTION SIGNS WITH APPROVED LEGEND WHERE INSTRUCTIONS OR EXPLANATIONS ARE NEEDED FOR SYSTEM OR EQUIPMENT OPERATION. INSTALL BUTYRATE SIGNS WITH METAL BACKING FOR OUTDOOR ITEMS.

END OF GENERAL ELECTRICAL REQUIREMENTS

LOW-VOLTAGE ELECTRICAL POWER CONDUCTORS AND CABLES

- THIS SECTION DETAILS GENERAL REQUIREMENTS FOR LOW VOLTAGE POWER AND CONTROL WIRE, CABLE AND ACCESSORIES, RATED UP TO 600
- SHARING OF NEUTRAL WIRES FOR MULTIPLE SINGLE-PHASE CIRCUITS IS PROHIBITED. MC CABLE TO BE COLOR CODED BASED ON SYSTEM USE, AS **FOLLOWS** MC CABLE USED FOR BUILDING AUTOMATION SYSTEM (BAS)
- CONTROL WIRING: BLUE MC CABLE USED FOR FIRE ALARM WIRING: RED IDENTIFY WIRE AND CABLE WITH ITS CIRCUIT NUMBER OR OTHER
- DESIGNATION INDICATED.
- CABLES SHALL BE DIRECTLY SUPPORTED TO BUILDING STRUCTURE AND INDEPENDENT OF OTHER PIPING, MECHANICAL EQUIPMENT OR CEILING SUPPORTS; CABLE SUPPORTS SHALL BE DEVICES SUCH AS "CADDY CLIPS" AND "BRIDLE RING" SUPPORTS AND "J HOOKS", LISTED FOR THE INTENDED
- NYLON TIE WRAPS ARE NOT ACCEPTABLE FOR CABLE SUPPORTS; THEY ARE ACCEPTABLE FOR CABLE TRAINING AND BUNDLING
- FOR EXISTING WORK: DISCONNECT ABANDONED CIRCUITS AND REMOVE CIRCUIT WIRE
- AND CABLE; REMOVE ABANDONED BOXES WHEN WIRE AND CABLE SERVICING BOXES IS ABANDONED AND REMOVED; INSTALL BLANK COVERS FOR ABANDONED BOXES NOT REMOVED MAINTAIN ACCESS TO EXISTING WIRING CONNECTIONS REMAINING

ACTIVE AND REQUIRING ACCESS

GENERAL

- CONDUCTORS AND CABLES COPPER BUILDING WIRE, RATED 600 V OR LESS, INSULATION: TYPE THHN
- OR TYPE XHHW-2 OR ROMEX WIRE. METAL-CLAD CABLE, TYPE MC, CONDUCTOR: COPPER WITH FULL-RATED GROUND CONDUCTOR.
- ALUMINUM BUILDING WIRE ARE NOT ALLOWED.
- MINIMUM CONDUCTOR SIZE IS 12 AWG FOR POWER AND LIGHTING
- MINIMUM CONDUCTOR SIZE IS 16 AWG FOR CLASS 2 AND 3 CONTROL

CONDUCTOR MATERIAL APPLICATIONS

- FEEDERS: SOLID FOR NO. 12 AWG AND SMALLER; STRANDED FOR NO. 10 BRANCH CIRCUITS: SOLID FOR NO. 10 AWG AND SMALLER: STRANDED FOR
- NO. 8 AWG AND LARGER, EXCEPT VFC CABLE, WHICH SHALL BE EXTRA-FLEXIBLE STRANDED. CONDUCTOR INSULATION AND MULTICONDUCTOR CABLE APPLICATIONS
- AND WIRING METHODS EXPOSED FEEDERS: TYPE THHN/THWN-2, SINGLE CONDUCTORS IN
- EXPOSED BRANCH CIRCUITS: TYPE THHN/THWN-2, SINGLE CONDUCTORS IN RACEWAY, METAL-CLAD CABLE, TYPE MC
- BRANCH CIRCUITS CONCEALED IN CEILINGS, WALLS, AND PARTITIONS
- METAL-CLAD CABLE, TYPE MC VFC OUTPUT CIRCUITS: TYPE TC-ER CABLE WITH BRAIDED SHIELD

TERMINATIONS SPLICES AND TAPS UNDER 600 VOLTS:

- 10 AWG AND SMALLER: COPPER COMPRESSION TYPE OR TWIST-ON METAL SPRING-TYPE CONNECTORS WITH COLOR-CODED INSULATING NYLON COVERING. CONNECTORS FOR EXTERIOR AND DIRECT BURIAL USE SHALL BE LISTED FOR THE APPLICATION.
- 8 AWG AND LARGER: HYDRAULIC COMPRESSION CONNECTORS, MECHANICAL BOLTED PRESSURE TYPE, SUCH AS ILSCO CLEAR TAP, OR LISTED INSULATED TERMINAL BLOCKS.
- CABLE LUGS AND TERMINATIONS UNDER 600 VOLTS: 10 AWG AND SMALLER: COPPER COMPRESSION TYPE WITH COLOR-
- CODED INSULATING NYLON COVERING 8 AWG AND LARGER: HYDRAULIC COMPRESSION CONNECTORS,
- PRE-FILLED WITH ANTI-OXIDANT COMPOUND LUG CONNECTIONS TO BUS BARS: PROVIDE WITH TIN-PLATED LUGS AND "BELLEVILLE" STYLE WASHERS
- TAPE ALL TERMINATIONS TO MATCH CABLE INSULATION RATING C. "PUSH-ON" TYPE TERMINATORS AND SPLICE TAPS ARE NOT ACCEPTABLE.

FOR WIRE SIZES 6 AWG AND SMALLER. INSTALL WIRE COLORS IN

- ACCORDANCE WITH THE FOLLOWING BLACK AND RED FOR SINGLE PHASE CIRCUITS AT 120/240 VOLTS BLACK, BLUE, AND RED FOR CIRCUITS AT 120/208 VOLTS SINGLE OR THREE PHASE 3. BROWN, ORANGE, AND YELLOW FOR CIRCUITS AT
- 277/480 VOLTS SINGLE OR THREE PHASE FOR WIRE SIZES 4AWG AND LARGER, IDENTIFY WIRE WITH COLORED TAPE AT TERMINALS, SPLICES AND BOXES. COLORS ARE AS FOLLOWS:
- BLACK AND RED FOR SINGLE PHASE CIRCUITS AT 120/240 VOLTS BLACK, BLUE, AND RED FOR CIRCUITS AT 120/208 VOLTS SINGLE OR
- BROWN, ORANGE, AND YELLOW FOR CIRCUITS AT 277/480 VOLTS SINGLE OR THREE PHASE
- **NEUTRAL CONDUCTORS:** WHITE FOR 120/240 AND 120/208 VOLT CIRCUITS, AND GRAY WITH A YELLOW TRACER FOR 277/480 VOLT CIRCUITS
- WHEN TWO OR MORE NEUTRALS ARE LOCATED IN ONE CONDUIT. INDIVIDUALLY IDENTIFY EACH WITH PROPER CIRCUIT NUMBER WHEN A COMMON NEUTRAL IS USED A 200% RATED NEUTRAL SHALL BE PROVIDED

END OF SECTION LOW-VOLTAGE ELECTRICAL POWER CONDUCTORS AND CABLES

WIRING DEVICES

- PRODUCTS TOGGLE SWITCHES: 120/277 V, 20 A.
- SWITCHES: SINGLE POLE, MOTOR RATED DECORATOR-STYLE DEVICES: SQUARE FACE, 125 V, 20 A.
- COMMERCIAL GRADE, GFCI AND WEATHER-RESISTANT DUPLEX RECEPTACLE. COMMERCIAL GRADE SPLIT CONTROLLED RECEPTACLE
- WALL DIMMABLE SWITCH SENSOR LIGHT SWITCH, DUAL TECHNOLOGY.
- MATERIAL FOR FINISHED SPACES: STEEL WITH BAKED ENAMEL MATERIAL FOR UNFINISHED SPACES: GALVANIZED STEEL MATERIAL FOR DAMP AND WET LOCATIONS: CAST ALUMINUM.
- FINISHES: CONNECTED TO NORMAL POWER SYSTEM: WHITE CONTROLLED RECEPTACLE: GREEN AND MARKED.

END OF SECTION WIRING DEVICES

GROUNDING AND BONDING FOR ELECTRICAL SYSTEMS

QUALITY STANDARD FOR GROUNDING AND BONDING MATERIALS AND **EQUIPMENT: UL 467.**

PRODUCTS

- CONDUCTORS: INSULATED CONDUCTORS: COPPER OR TINNED-COPPER WIRE OR
- BARE COPPER CONDUCTORS:
- BONDING CABLE. BONDING CONDUCTOR.
- BONDING JUMPER. TINNED BONDING JUMPER.

CONNECTORS:

- WELDED. CABLE-TO-CABLE CONNECTORS.
 - CONDUIT HUBS. U-BOLT CLAMPS.

END OF GROUNDING AND BONDING FOR ELECTRICAL SYSTEMS

RACEWAYS AND BOXES FOR ELECTRICAL SYSTEMS

- METAL CONDUITS MINIMUM CONDUIT 3/4 INCH
- PVC-COATED RIGID STEEL CONDUIT
- FITTINGS:
- EMT: STEEL; DIE CAST FITTING IS NOT ALLOWED. COMPRESSION TYPE. - EXPANSION FITTINGS OR PVC COATED.
- NONMETALLIC CONDUIT AND FITTINGS:
- FITTINGS: MATCH CONDUIT
- BOXES, ENCLOSURES, AND CABINETS METAL OUTLET AND DEVICE BOXES: FERROUS ALLOY
- NONMETALLIC OUTLET AND DEVICE BOXES. SMALL SHEET METAL PULL AND JUNCTION BOXES. CAST-METAL ACCESS, PULL, AND JUNCTION BOXES
- BOX EXTENSIONS.
- GANGABLE BOXES ARE PROHIBITED. HINGED-COVER ENCLOSURES: METAL

CABINETS: GALVANIZED STEEL. RACEWAY APPLICATION

- OUTDOORS: EXPOSED: IMC.
- CONCEALED, ABOVEGROUND: RNC, TYPE EPC-40-PVC. UNDERGROUND: RNC, TYPE EPC-80-PVC CONNECTION TO VIBRATING EQUIPMENT: LFMC
- BOXES AND ENCLOSURES, ABOVEGROUND: TYPE 3R.
- EXPOSED, NOT SUBJECT TO PHYSICAL DAMAGE: EMT EXPOSED, NOT SUBJECT TO SEVERE PHYSICAL DAMAGE: EMT EXPOSED AND SUBJECT TO SEVERE DAMAGE: IMC.
- CONCEALED: EMT CONNECTION TO VIBRATING EQUIPMENT: FMC, EXCEPT LFMC IN DAMP OR WET LOCATIONS.
- DAMP OR WET LOCATIONS: IMC. BOXES AND ENCLOSURES: TYPE 1, EXCEPT TYPE 4 STAINLESS STEEL IN COMMERCIAL KITCHENS AND DAMP OR WET LOCATIONS.
- MINIMUM RACEWAY SIZE: 3/4-INCH TRADE SIZE. RACEWAY FITTINGS: COMPATIBLE WITH RACEWAYS AND SUITABLE FOR USE AND LOCATION.
- RIGID AND INTERMEDIATE STEEL CONDUIT: THREADED RIGID STEEL PVC EXTERNALLY COATED, RIGID STEEL CONDUITS: FITTINGS
- LISTED FOR USE WITH THIS TYPE OF CONDUIT. EMT: COMPRESSION, STEEL FITTINGS.
- FLEXIBLE CONDUIT: FITTINGS LISTED FOR USE WITH FLEXIBLE

END OF SECTION RACEWAYS AND BOXES FOR ELECTRICAL SYSTEMS

LED INTERIOR LIGHTING

- MATERIALS AND WORKMANSHIP FOR LUMINAIRES: FIVE YEARS.
- PRODUCTS
- OPERATING NOMINAL VOLTAGE: MVOT. LUMINAIRE TYPES: REFER TO LIGHT FIXTURE SCHEDULE INDICATED ON
- DRAWING. LIGHTING DIFFUSERS: AT LEAST 0.125 INCH PRISMATIC UV-STABILIZED
- LED DRIVER: UL-LISTED 0-10V DIMMING
- RATED LAMP LIFE OF 50,000 HOURS TO L70.
- **HOUSINGS**: EXTRUDED-ALUMINUM HOUSING AND HEAT SINK. POWDER-COAT PAINTED FINISH.
- FREE OF BURRS AND SHARP CORNERS AND EDGES. SHEET METAL COMPONENTS SHALL BE STEEL UNLESS OTHERWISE
- FORM AND SUPPORT TO PREVENT WARPING AND SAGGING DOORS, FRAMES, AND OTHER INTERNAL ACCESS; SMOOTH OPERATING, FREE OF LIGHT LEAKAGE UNDER OPERATING CONDITIONS, AND DESIGNED TO PERMIT RELAMPING WITHOUT USE OF TOOLS. DESIGNED TO PREVENT DOORS, FRAMES, LENSES, DIFFUSERS, AND OTHER COMPONENTS FROM
- FALLING ACCIDENTALLY DURING RELAMPING AND WHEN SECURED IN OPERATING POSITION. FACTORY-APPLIED LABELS: LABELS SHALL INCLUDE THE FOLLOWING LAMP CHARACTERISTICS:
- "USE ONLY" AND INCLUDE SPECIFIC LAMP TYPE. LAMP DIAMETER, SHAPE, SIZE, WATTAGE, AND COATING. CCT AND CRI FOR ALL LUMINAIRES.
- LUMINAIRE SUPPORT: SINGLE-STEM HANGERS: STEEL TUBING WITH SWIVEL BALL FITTINGS AND CEILING CANOPY
 - WIRES: SOFT TEMPER, ZINC-COATED STEEL, 12 GAGE. ROD HANGERS: CADMIUM-PLATED, THREADED STEEL ROD. HOOK HANGERS: INTEGRATED ASSEMBLY MATCHED TO LUMINAIRE. LINE VOLTAGE, AND EQUIPMENT WITH THREADED ATTACHMENT, CORD, AND LOCKING-TYPE PLUG.

END OF SECTION LED INTERIOR LIGHTING

ELECTRICAL TESTING

- THIS SECTION DESCRIBES THE INSPECTION AND TESTING OF ELECTRICAL SYSTEM COMPONENTS AND EQUIPMENT INSTALLED DURING NEW CONSTRUCTION OR AS PART OF ANY RENOVATION AND IMPROVEMENT
- ALL TESTING TO BE PERFORMED BY AN APPROVED INDEPENDENT TESTING
- AND INSPECTION AGENCY.
- ELECTRICAL SYSTEMS AND COMPONENTS REQUIRING FIELD TESTING AND
- INSPECTION INCLUDE, BUT ARE NOT LIMITED TO: ELECTRICAL GROUNDING ELECTRODE SYSTEM - ELECTRICAL
- SYSTEM RENOVATIONS/NEW CONSTRUCTION INTERNAL BUILDING GROUNDING SYSTEMS AND ISOLATED **GROUND SYSTEMS**
- WIRE AND CABLE RATED 100 AMPS AND LARGER OR OPERATING OVER 600 VOLTS
- FOLLOW RECOMMENDATIONS AND TEST PROCEDURES AS OUTLINED IN NETA (INTERNATIONAL ELECTRICAL TESTING ASSOCIATION) WHERE STANDARD FIELD TEST PROCEDURES ARE PROVIDED
- TESTS OR INSPECTION SHALL BE CORRECTED PROMPTLY AND RETESTED. PROVIDE ACCEPTANCE TESTING REPORTS PRIOR TO THE DATE OF SUBSTANTIAL COMPLETION AND ACCEPTANCE DEMONSTRATIONS. PROVIDE ACCEPTANCE TESTING REPORTS AND THE AS-LEFT FINAL DEVICE SETTINGS (FOR ALL ADJUSTABLE-TRIP CIRCUIT BREAKERS, RELAYS AND

FAILURE OR DEFECTS IN WORKMANSHIP OR MATERIALS REVEALED BY

FIELD TEST CIRCUIT BREAKERS AND PROTECTIVE RELAYS USING SECONDARY INJECTION TESTING. CALIBRATION TO BE PERFORMED BY AN

OTHER PROTECTIVE DEVICES) IN THE OPERATION AND MAINTENANCE

- APPROVED INDEPENDENT TESTING AND INSPECTION AGENCY. TEST AND INSPECT ALL CIRCUITS AND RECEPTACLES FOR PROPER
- NEUTRAL AND GROUNDING CONNECTIONS. DEMONSTRATE THE PROPER OPERATION OF THE ELECTRICAL SYSTEMS INSTALLED BELOW, ALONG WITH INTERFACES TO OTHER SYSTEMS, SUCH AS BUILDING AUTOMATION SYSTEM (BAS).

GROUNDING SYSTEMS:

- TEST GROUND GRID SYSTEMS USING THE THREE TERMINAL FALL IN POTENTIAL METHOD.
- TEST BUILDING GROUNDING SYSTEMS AND CIRCUIT GROUNDS TO ENSURE CONTINUITY OF THE GROUND RETURN PATHS. TESTING TO BE PERFORMED BY AN APPROVED INDEPENDENT TESTING
- AND INSPECTION AGENCY. TEST FOR PROPER SYSTEM OPERATION ON POWER FAILURE

END OF SECTION **ELECTRICAL TESTING**

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